



**ACOUSTICAL AND VIBRATION REPORT  
696 CHATHAM STREET WEST  
RESIDENTIAL CONDO DEVELOPMENT  
WINDSOR, ONTARIO**

PROJECT NO. 21-170

DATED: JANUARY 18, 2023



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## 1. INTRODUCTION

Baird AE has been retained to prepare an acoustical and vibration report in support of a proposed 16-storey Residential Condominium Development for land located at 696 Chatham Street West in the City of Windsor.

The proposed development will include residential units on a 0.12 ha (0.30 ac) parcel. The development is bounded by a parking lot to the north, Chatham Street to the south, Caron Avenue to the west and mixed-use areas to the east.

The proposed building will be sixteen (16) storeys tall. Floor 1 will have an amenity area, lobby and tenant storage, Floor 2-4 consists of parking spaces, and the rest of the floors (floors 5 to 16) contain the proposed 88 residential units.

The subject property is within 300 meters of a Rail Corridor and Rail Yard, as shown on Schedule F-1 of the City of Windsor Official Plan. Based on Sections 7.2.8.9 and 10.2.11 of the Official Plan, a study is required.

This report will recommend mitigation measures based on criteria set by the Ministry of Environment and Climate Change (MOECC) and the CP railway. Access to the development will be provided from Chatham Street West. The property is shown in Exhibit 1.



**Exhibit 1 - Location Plan**

## **2. NOISE CRITERIA**

The MOECC publication NPC-300 “Environmental Noise Guideline Stationary and Transportation Sources – Approval and Planning” was used in this noise study. Based on the initial investigation, the primary noise affecting the development is from the CP railway corridor and Rail Yard. Air traffic noise was not considered, as the development is located outside the zone of influence of local airports.

Due to the physical features of the surroundings (i.e., a significant urban setting), it is assumed that the development is located in a “Class 1” area defined by MOECC. This class of area has an acoustical environment typical of a major population center during the daytime and night time hours. The “Class 1” MOECC criteria for noise levels resulting from traffic and stationary sources for this development are summarized in Table 1.

**Table 1 – MOECC Noise Level Criteria – (Road)**

Location	Time Period	Noise Levels Requirement
Outdoor - Living Areas	07:00 - 23:00	<55dBA – No Control
		55 to 60dBA – Physical Control or Type A Clause
		> 60dBA – Physical Control and Type B Clause
Outside - Living/dining Plane of Window	07:00 - 23:00	<55dBA – No Control
		55 to 65dBA – Forced Air and Type C Clause
		> 65dBA – Air Conditioner, Type D Clause and Building Components
Outside - Living/dining Plane of Window	23:00 to 07:00	<50dBA – No Control
		50 to 60dBA – Forced Air and Type C Clause
		> 60dBA – Air Conditioner, Type D Clause and Building Components

MOECC Guidelines NPC-300 Section C7.1.1 and C7.1.2 – August 2013

**Table 2 – MOECC Noise Level Criteria – Indoor**

Type of Space	Type of Space	Sound Exposure Level	
		Road	Rail
Living/Dining Room	0700 - 2300	45 dBA	40 dBA
	2300 - 0700	45 dBA	35 dBA
Sleeping Quarters	0700 - 2300	45 dBA	40 dBA
	2300 - 0700	40 dBA	35 dBA

MOECC Guidelines NPC-300 Section C3.2.3 – August 2013


Table 2 describes indoor sound level limits that are used to calculate the Sound Transmission Class (STC) should outdoor sound level limits be triggered for building components.

**Table 3 – MOECC Noise Level Criteria – Stationary**

Time Period	Outdoor Points of Reception	Plane of Window
0700 - 1900	50 dBA	50 dBA
1900 - 0700	45 dBA	45 dBA

Source: MOECC publication NPC-300 "Sound level limits for Stationary Sources in Class 1 & 2 Areas (Rural)", Tables C-5, C-6; August 2013.

Due to the 300m proximity to the railway corridor and yard, stationary sources limits are considered and limits are provided in Table 3. Indoor sound level limits are used to calculate Sound Transmission Class (STC) when stationary sources are available. Exhibit 2 depicts the railway proximity in relation to the subject property.

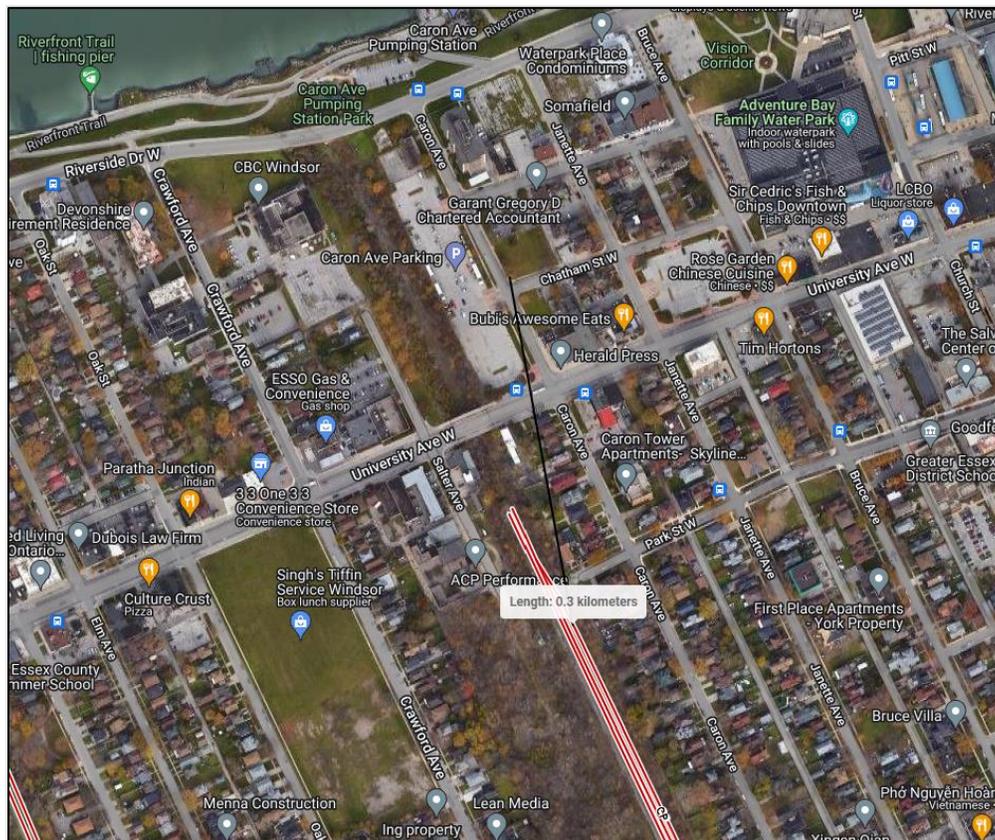

**Exhibit 2 – Railway Proximity Map**

## 2.1 Receiver Locations

The sample receiver locations were identified and are located at the worst-case locations (most exposed) for both day and nighttime noise. For daytime, receivers are placed 1.5m above ground (floor) and for nighttime receivers are placed 4.5m above ground.

For indoor living areas, the plane of window (POW) will be used to represent the worst case for both daytime and nighttime receivers.

The term “outdoor living area” (OLA) is used to refer to an outdoor patio, a backyard, a terrace, balconies or other areas where passive recreation is expected to occur. A review of the site plan indicates that the proposed building will have a 5<sup>th</sup> Floor Amenity Deck. The amenity space depth is more than 4m which is considered an OLA. It is noted that the dwelling units will have private balconies under 4 meters in minimum depth and aren’t considered OLA’s, as per the Ministry guidelines.

Table 4 identifies the various receiver heights chosen as the “worst case” locations within the proposed development. These locations are shown in Appendix A, Figure 1.

**Table 4 – Receiver Locations**

Receiver Location	Height of Receivers		Represents
	Grade (m)	Type	
Receiver OLA – Floor 5	15.2m	OLA	West facades
Receiver – Floor 5	15.2m	POW	South, West facades
Receiver – Floor 6	19.4m	POW	South, West facades
Receiver – Floor 7	22.4m	POW	South, West facades
Receiver – Floor 10	31.6m	POW	South, West facades
Receiver – Floor 14	43.4m	POW	South, West facades
Receiver – Floor 16	49.8m	POW	South, West facades

## 2.2 *Stationary Noise Source*

A review of all surrounding users was conducted and two properties were identified as being potentially significant noise sources, namely:

CP Railway Corridor and Railway Yard – to the southwest of the subject property: the yard is within a 300m buffer area and it operates 24/7 with continuous operations.

Ambient noise levels at both monitoring locations are dominated by traffic noise from University Avenue. Whereas no significant noise was observable except for hydraulic brakes from the stationary noise sources despite the proximity of the CP yard.

Noise level monitoring was conducted on November 22, 2022 (weekday) at 3:30 pm for 20 minutes at two locations. Measurements were taken using an Extech Noise Meter model 407780A noise monitoring device. The sound levels were measured at a height of 1.5m above the ground. The following measurements were taken:

- a) The first measurement was taken on the subject property at the northeast corner of Caron Avenue and Chatham Street West.
- b) The second monitoring location was 55m from the intersection of Caron Avenue and Chatham Street West. The monitored noise level was 56.4 dBA.

## 2.3 *Noise Environment*

In order to obtain the current noise level, noise level monitoring was conducted at two locations on Tuesday, November 22, 2022, for 20 minutes. Measurements were taken using an Extech Noise Meter model 407780A noise monitoring device. The sound levels were measured at a height of 1.5m above the ground. The equivalent sound pressure level (Leq) at the monitoring locations is provided in Table 5 and shown in Appendix A, Figure 1.

**Table 5 – Transportation Noise Level**

<b>Receiver Location</b>	<b>Monitoring Level Daytime (dBA)</b>
Monitoring 1	53 (avg) – 66.4 (max)
Monitoring 2	56.4 (avg) – 73.3 (max)

The noise propagation analysis was completed using the noise modelling program “iNoise”, produced by DGMR Software to match the monitoring noise levels at monitoring locations M1 and M2 from surrounding sources. The iNoise program follows International Standards Organization (ISO) standards 9613 parts 1 and 2. The model is capable of incorporating various site features such as elevations, berms, absorptive grounds and barriers to accurately predict noise levels at specific receptors, pertaining to noise emission from sources. The model is considered conservative since it represents the atmospheric condition that promotes the propagation of sound from the source to the receiver.

The following assumptions were used in the iNoise modelling:

Reflections: A building reflection of 0.8 was assumed to be representative of the brick façade present for the surrounding building including the proposed building.

Ground Absorption & Topography: A ground absorption coefficient of 0 was used to represent the most reflective (i.e., paved surface) The area surrounding the monitoring location is characterized by generally flat. As such, topography was not incorporated into the noise modelling.

The potential significant noise sources associated with rail and roadway sources have been assumed as well. Details are provided in Appendix A. The following potential stationary and transportation noise levels were established for iNoise software:

- The Locomotive Diesel engine noise level is 99.2dBA.
- The hand-held hydraulic brake noise level is 111.2dBA.
- Rail whistle noise to be 115dBA.
- Roadway car noise level is 79.2dBA at 50km/h speed.
- Slow moving truck noise level is 95.4dBA.

### **3. NOISE ASSESSMENT**

Overall unattenuated daytime and nighttime sound levels at the receiver locations are shown in Figure 3 and are described in Table 6.

**Table 6 – Post Development Predicted Noise Levels**

Location	Noise Level (dBA)			MOECC Criteria (dBA) Rail	Meets MOECC
	Receiver 1	Receiver 2	Receiver 3		
Floor 5 OLA Daytime	38	--	--	60	Yes
Floor 5 Daytime	53	53	53	40	No
Nighttime	49	49	50	35	No
Floor 6 Daytime	52	52	52	40	No
Nighttime	49	49	49	35	No
Floor 7 Daytime	52	52	52	40	No
Nighttime	49	49	49	35	No
Floor 10 Daytime	52	52	52	40	No
Nighttime	49	49	49	35	No
Floor 14 Daytime	52	52	52	40	No
Nighttime	49	49	49	35	No
Floor 16 Daytime	52	52	52	40	No
Nighttime	49	49	49	35	No

Based on predicted sound levels as shown in figures 2 and 3 (Appendix B) and table 7, mitigation measures are required, such as warning clauses, required to meet the MOECC Limit of 40dBA daytime and 35dBA nighttime. Mitigation measures are provided in Section 4.

For indoor living and bedroom areas, daytime and nighttime noise levels are above 40 dBA during daytime and 35 dBA at nighttime for all receiver locations, therefore, an assessment of glazing requirements is necessary to meet the indoor sound levels for buildings at all receiver locations.

## 4. MITIGATION MEASURES

### Acoustical Fence

No acoustical fence is needed as the noise level is less than 60dBA for the OLA for common balconies on the 5<sup>th</sup> floor.

### Building Components

To calculate the required building components, the dimensions of the rooms and their wall/window sizes must be known. Table 7 summarizes the building component areas.

**Table 7 – Building Component Sizes**

South, West Façade	Window	Door	Floor
Bedroom	3.3 m <sup>2</sup>	2.3 m <sup>2</sup>	8.7 m <sup>2</sup>
Living room	3.3 m <sup>2</sup>	2.3 m <sup>2</sup>	11.7 m <sup>2</sup>

Detailed calculations are included in Appendix D, and Table 8 summarizes the required STC values for the various façades. Sample building components and their associated STC ratings are included in Appendix D.

**Table 8 – Required STC Values (Window/Door)**

Location	Type	South Façade	East Façade	West/North Façade
Level 6 - 10	Bedroom	36	35	36
	Living	29/30	27/29	29/30
Level 10 - 16	Bedroom	35	34	34
	Living	28/30	27/29	27/30

It is also recommended that an acoustical consultant review the building components to ensure that noise levels satisfy the requirements, as stated in Table 8. For the proposed development, the estimated building components are shown in Appendix B, Figure 1.

The Ontario Building Code (OBC) section 5.8.1 specifies the minimum required sound insulation characteristics for partitions in terms of Sound Transmission Class (STC) values.

For acoustic privacy in a multi-tenant building between suites, the inter-unit wall should meet or exceed STC-50. Walls separating suites from noisy spaces, such as refuse chutes or elevator shafts, should meet or exceed STC-55. In addition, it is recommended that the separation of suites from any amenity or commercial space for building component (floor/ceiling) construction also meet or exceed STC-55.

## 5. VIBRATION MONITORING

Vibration measurement was completed on November 22, 2022, and the location is labelled VIB A in Appendix A, Figure 1. The vibration analyzer SSEYL Landtek VM3670 was securely placed on top of the concrete surface to measure the ground vibration generated by light and heavy vehicles. Details are provided in Appendix B. Vibration ranges are:

- Velocity: 0.01 to 0.69 mm/s
- Displacement: 0.002mm to 0.025mm
- Acceleration: 0.00 mm/s<sup>2</sup>

It is therefore recommended that the building design incorporate the maximum vibration parameters in addition to the requirements of section 4.1.3.6 of the OBC.

## 6. RECOMMENDATIONS

As demonstrated in this report, mitigation measures are required to bring residential units within the development into compliance with MOECC criteria. With the inclusion of these measures, MOECC noise criteria will be satisfied.

### **Recommendation #1 (All Units Within Developments)**

Due to the exceedance of the MOECC criteria for daytime and nighttime acoustical levels from CP Rail Corridor and Rail Yard, the units are to be equipped with air conditioning and forced air heating. Further, these units shall include the following warning clause:

"Due to its proximity to Chatham Street West and CP railway, these dwelling units has been supplied with a central air conditioning system which will allow windows and exterior doors to remain closed, thereby ensuring that the indoor sound levels are within the sound level limits of the Municipality and the Ministry of the Environment, Conservation and Parks."

## **Recommendation #2 (All Units Within Developments)**

A noise warning clause should be included in the property and tenancy agreements and offer of purchase and sale for the dwelling units to inform the future owners/occupants of the noise issues and the presence of the existing facilities, and that sound from these facilities may at time be audible during a period of low background sound and which read as follows:

"Purchasers/tenants are advised that due to the proximity of the adjacent roadway and CP facility, noise from the railway may at times be audible."

## **Recommendation #3 (Building Components)**

Due to exposure to train noise, the units facing south, west and north facades require special building components for areas of sensitive use (i.e., bedroom, living room, dining room, kitchen, etc.) and the following are required:

### Window Requirements:

All windows leading to sensitive living areas are to have a minimum Sound Transmission Class as provided in Table 8 in order to meet the MOECC indoor noise level criteria.

### Door Requirements:

All doors leading to sensitive living areas are to have a minimum Sound Transmission Class as provided in Table 8 in order to meet the MOECC indoor noise level criteria.

### Wall Requirements:

Acoustic privacy between units in a multi-tenant building, the inter-unit wall, should meet or exceed Sound Transmission Class 50. Wall separation between noisy spaces, such as refuse chutes or elevator shafts, and suites should meet or exceed Sound Transmission Class 55.

Further, these units shall include the following warning clause in the purchase or lease agreements:

"Purchasers/tenants are advised that due to close proximity of the adjacent industries, noise from said industries may at times be audible."

**Recommendation #4 (All units within the development)**

Prior to the issuance of building permits, it is recommended that an acoustical consultant review the Sound Transmission Class for the proposed development's walls, windows and doors to ensure they conform to the recommendations outlined in this report.

**Recommendation #5 (All units within the development)**

The design of the building should consider the monitored vibration values in addition to those provided in section 4.1.3.6 of the Ontario Building Code.

**7. SUMMARY**

We conclude that this development can, with the implementation of the above-described mitigation measures, be designed to address impacts from the surrounding noise sources.

If you have any questions or wish to discuss our findings, please advise us.

Yours truly,

**BAIRD AE INC.**  
**27 PRINCESS STREET, UNIT 102**  
**LEAMINGTON, ONTARIO N8H 2X8**


Shurjeel Tunio, P.Eng.  
Senior Project Manager  
**Baird AE**



## Appendix A

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### NOISE INFORMATION PLAN AND BACKGROUND INFORMATION

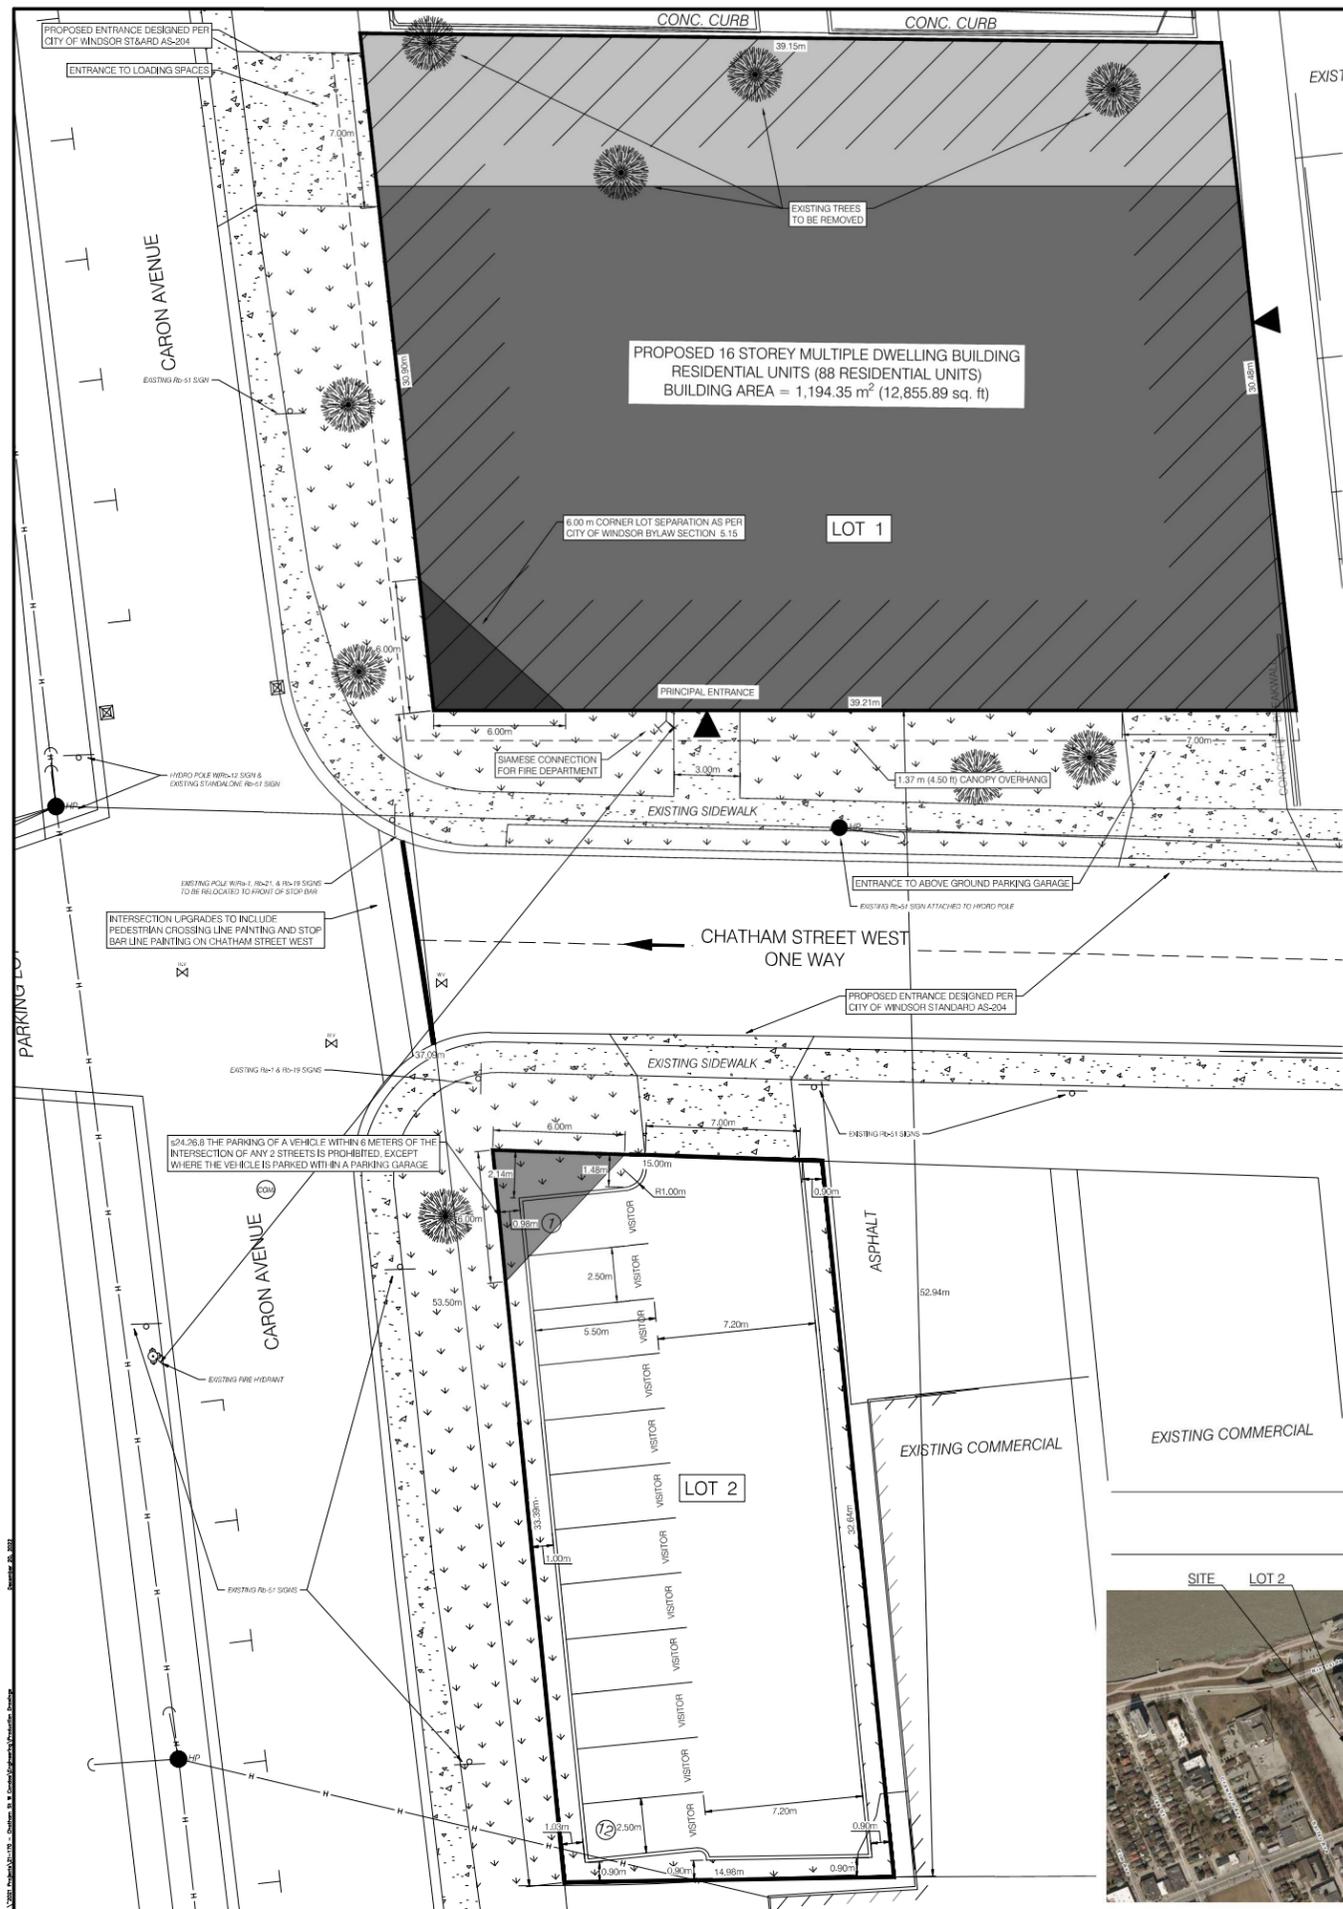

**LEGEND**

①	NUMBERED PARKING SPACES
○	PARKING/ROAD SIGN
⦿	FIRE HYDRANT
▲	BUILDING ENTRANCE
●	HYDRO POLE (HP)
—	OVERHEAD HYDRO CABLE
⌒	GUY WIRE
⊠	EXISTING CATCH BASIN
⊝	EXISTING COMBINED SEWER MANHOLE
⊞	EXISTING WATER VALVE
●	EXISTING TREES
□	LANDSCAPE OPEN SPACE
▨	SIDEWALK/CONCRETE
▩	PROPOSED BUILDING
▧	PROPOSED 5 STOREY PODIUM (FLOORS 1-5)
▨	PROPOSED 11 STOREY TOWER (FLOORS 6-16)
—	PROPERTY LINE

**KEY PLAN**  
1:2500



SITE DATA:			
SITE ZONING:	COMMERCIAL DISTRICT 3.6 (CD3.6)		
PERMITTED USE:	RETAIL STORE, DWELLING UNITS IN A COMBINED USE BUILDING WITH ANY ONE OR MORE PREVIOUSLY LISTED USES, AMONGST OTHER USES PERMITTED WITHIN THE CD3.6 ZONE		
PROPOSED ZONING:	COMMERCIAL DISTRICT 3.6 SITE SPECIFIC PROVISION XX (CD3.6-S.20(1)XX)		
PROPOSED USE:	MULTIPLE DWELLING BUILDING, AMONGST OTHER USES WITHIN THE CD3.6-S.20(1)XX ZONE		
DESCRIPTION:	REQUIRED:	PROVIDED:	ZONING COMPLIANCE:
MIN. LOT AREA:	N/A	1,194.35 m <sup>2</sup> (12,855.89 sq. ft) 0.12 ha (0.30 ac)	COMPLIES
MIN. FRONTAGE:	N/A	30.90 m (101.38 ft)	COMPLIES
MIN. INTERIOR YARD SETBACK (NORTH):	N/A	0.00 m (0.00 ft)	COMPLIES
MIN. EXTERIOR YARD SETBACK (SOUTH):	N/A	0.00 m (0.00 ft)	COMPLIES
MIN. REAR YARD SETBACK (EAST):	N/A	0.00 m (0.00 ft)	COMPLIES
MIN. FRONT YARD SETBACK (WEST):	N/A	0.00 m (0.00 ft)	COMPLIES
LOT COVERAGE:	N/A	100.00% (1,194.35 m <sup>2</sup> , 12,855.89 sq. ft)	COMPLIES
BUILDING HEIGHT:	MAX. 20.00 m (65.62 ft)	53.34m (175.00 ft)	RELIEF REQUESTED
DRIVE-WAY WIDTH:	MIN. 3.50 m (11.48 ft)	7.00 m (22.96 ft)	COMPLIES
CORNER LOT:	MIN. 6.00 m (19.69 ft) SEPARATION BETWEEN ANY PART OF ANY BUILDING OR STRUCTURE & THE POINT OF INTERSECTION OF ANY 2 STREETS	0.00 m (0.00 ft)	RELIEF REQUESTED
AMENITY AREA: (INCLUDES YOGA ROOM, FITNESS ROOM, 2 LOUNGES, GAMES ROOM, PARTY ROOM & OPEN AMENITY DECK - REFER TO FLOOR PLANS 1 & 5)	MIN. OF 12.00 m <sup>2</sup> (129.17 sq. ft) PER DWELLING UNIT 88 DWELLING UNITS @ 12.00 m <sup>2</sup> = 1,056.00 m <sup>2</sup> (11,366.69 sq. ft) REQ.	10.89 m <sup>2</sup> PER DWELLING UNIT PROV. TOTAL PROV. = 958.62 m <sup>2</sup> (10,318.47 sq. ft)	RELIEF REQUESTED
PARKING FOR MULTIPLE DWELLING BUILDING - DWELLING UNITS (INCLUDES REQ. # OF ACCESSIBLE SPACES):  (PLEASE SEE FLOORS 2-4 FLOOR PLAN SHEET FOR PARKING SPACE LOCATION)	SITE LOCATED WITHIN CITY OF WINDSOR CENTRAL BUSINESS DISTRICT THEREFORE NO SPACES REQUIRED FOR FIRST 6 DWELLING UNITS & 1 SPACE FOR EACH ADDITIONAL DWELLING UNIT = 88 UNITS = 82 SPACES REQ.	82 SPACES PROV.	COMPLIES
ACCESSIBLE PARKING:  (PLEASE SEE FLOORS 2 & 3 FLOOR PLAN SHEET FOR ACCESSIBLE PARKING SPACE LOCATION)	TYPE A SPACE: 2% OF PARKING SPACES = 2 SPACES  TYPE B SPACE: 2% OF PARKING SPACES = 2 SPACES  4 ACCESSIBLE SPACES TOTAL	4 SPACES PROV.  2 TYPE 'A' SPACES 2 TYPE 'B' SPACES	COMPLIES
VISITOR PARKING SPACES:	MIN. 15% OF PARKING SPACES TO BE MARKED AS VISITOR PARKING = 12 VISITOR SPACES REQ.	12 SPACES PROV.	COMPLIES
BIKE PARKING SPACES:  (PLEASE SEE FIRST FLOOR PLAN SHEET FOR TENANT STORAGE LOCATION)	2 FOR THE FIRST 19 SPACES PLUS 1 FOR EACH ADDITIONAL 20 SPACES = 6 SPACES REQ.	6 SPACES PROV.	COMPLIES
LOADING SPACES:  (PLEASE SEE FIRST FLOOR PLAN SHEET FOR LOADING SPACE LOCATION)	RESIDENTIAL DWELLING UNITS SPACES REQ. BASED ON GFA: RESIDENTIAL GFA = 8,836.94 m <sup>2</sup> (95,120.00 sq. ft); THEREFORE 2 SPACES REQ.	2 SPACES PROV.	COMPLIES
PARKING AREA SEPARATION REQUIREMENTS FOR LOT 2			
PARKING AREA FROM:	MINIMUM SEPARATION REQ.	MINIMUM SEPARATION PROV.	ZONING COMPLIANCE:
ANY OTHER STREET	3.00 m (9.84 ft)	0.98 m (3.22 ft)	RELIEF REQUESTED
AN INTERIOR LOT LINE OR ALLEY	0.90 m (2.95 ft)	0.90 m (2.95 ft)	COMPLIES
s24.26.8 THE PARKING OF A VEHICLE WITHIN 6 METERS OF THE INTERSECTION OF ANY 2 STREETS IS PROHIBITED EXCEPT WHERE THE VEHICLE IS PARKED WITHIN A PARKING GARAGE	6.00 m (19.69 ft)	0.00 m (0.00 ft)	RELIEF REQUESTED
FOR ALL DWELLINGS OR DWELLING UNITS IN A COMBINED USE BUILDING, ALL REQUIRED PARKING SPACES, VISITOR PARKING SPACES & ACCESSIBLE PARKING SPACES SHALL BE LOCATED ON THE SAME LOT AS THE DWELLINGS OR DWELLING UNITS THEY ARE INTENDED TO SERVE	0.00 m (0.00 ft)	53.50 m (175.52 ft) LOCATED WITHIN 53.50 m OF THE NEAREST LOT LINE OF THE L& OCCUPIED BY THE MULTIPLE DWELLING	RELIEF REQUESTED
LOT / BUILDING INFO:			
TOTAL LOT AREA LOT 1:	1,194.35 m <sup>2</sup> (12,855.89 sq. ft) 0.12 ha (0.30 ac)		
LOT 2:	491.84 m <sup>2</sup> (5,294.08 sq. ft) 0.05 ha (0.12 ac)		
TOTAL BUILDING AREA:	1,194.35 m <sup>2</sup> (12,855.89 sq. ft)		
TOTAL RESIDENTIAL DWELLING UNITS:	88		
TOTAL RESIDENTIAL DWELLING GFA:	TOTAL = 8,836.93 m <sup>2</sup> (95,120.00 sq. ft); FLOOR 5 = 321.44 m <sup>2</sup> (3,460.00 sq. ft); FLOORS 6-14 = 6,973.30 m <sup>2</sup> (75,060.00 sq. ft); FLOORS 15 & 16 = 1,542.19 m <sup>2</sup> (16,600.00 sq. ft)		
HEIGHT OF BUILDING & NO. OF STOREYS:	53.34 m (175.00 ft) TALL & 16 STOREY		
TOTAL PARKING SPACES PROV. = 82 (ST&RD SPACES = 78, ACCESSIBLE SPACES = 4)			
BUILDING USE & OCCUPANCY:	RESIDENTIAL C		
NOTES:	<ol style="list-style-type: none"> <li>ALL FIRE DEPARTMENT SIGNAGE TO BE COMPLETED AFTER CONSTRUCTION IN COORDINATION WITH FIRE DEPARTMENT.</li> <li>ALL ACCESSIBLE TYPE 'A' SPACES TO HAVE RB-931 SIGNS INSTALLED &amp; TYPE 'B' SPACES TO HAVE RB-93 SIGNS INSTALLED.</li> <li>GARBAGE DISPOSAL UNIT LOCATED WITHIN THE BUILDING, TO BE ROLLED OUT TO LOADING AREAS FOR PRIVATE SERVICE PICK UP (PLEASE SEE FIRST FLOOR PLAN FOR LOCATION OF REFUSE AREA).</li> <li>ALL LIGHTING TO BE DARK SKY COMPLIANT.</li> <li>FIRE ROUTE TO BE IN COMPLIANCE WITH OBC REQUIREMENTS.</li> </ol>		

**BAIRD | AE**  
architecture + engineering


27 Princess Street, Unit 102  
Leamington ON N8H 2X8

1350 Provincial Road, Unit 700  
Windsor ON N8W 5W1

**CHATHAM ST. WEST CONDOS**  
606 CHATHAM ST. WEST WINDSOR, ONTARIO  
**CONCEPT SITE PLAN - OPA-ZBA SUBMISSION**

DATE: DECEMBER 20, 2022  
SCALE: 1:150  
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**1**

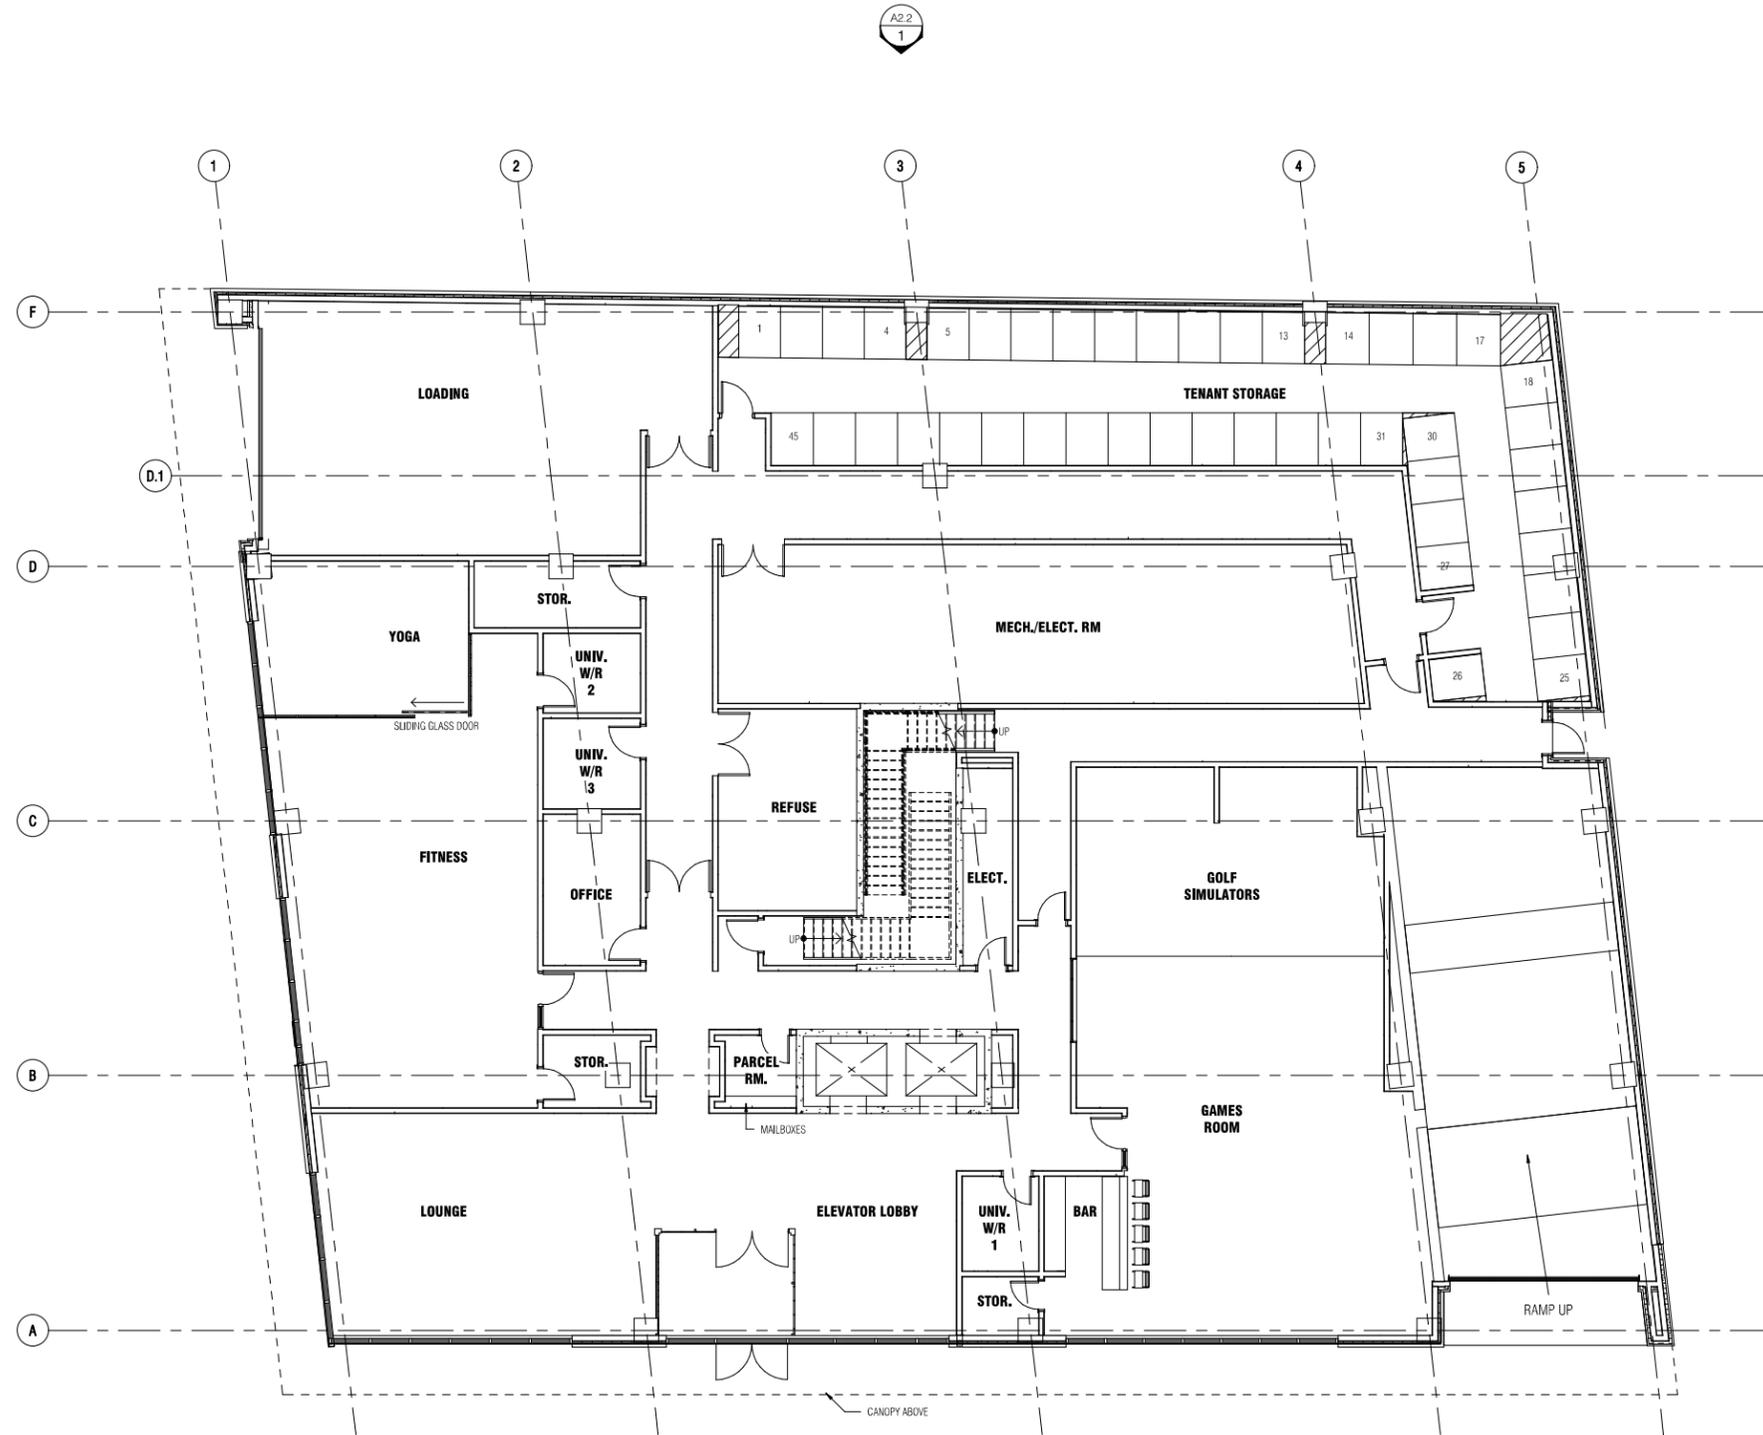


**FL-01**  
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NO.	DESCRIPTION	DATE
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**FL 02 - 03**  
SCALE: 1/8" = 1'-0"

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ISSUE		

NO.	DESCRIPTION	DATE
ISSUE		

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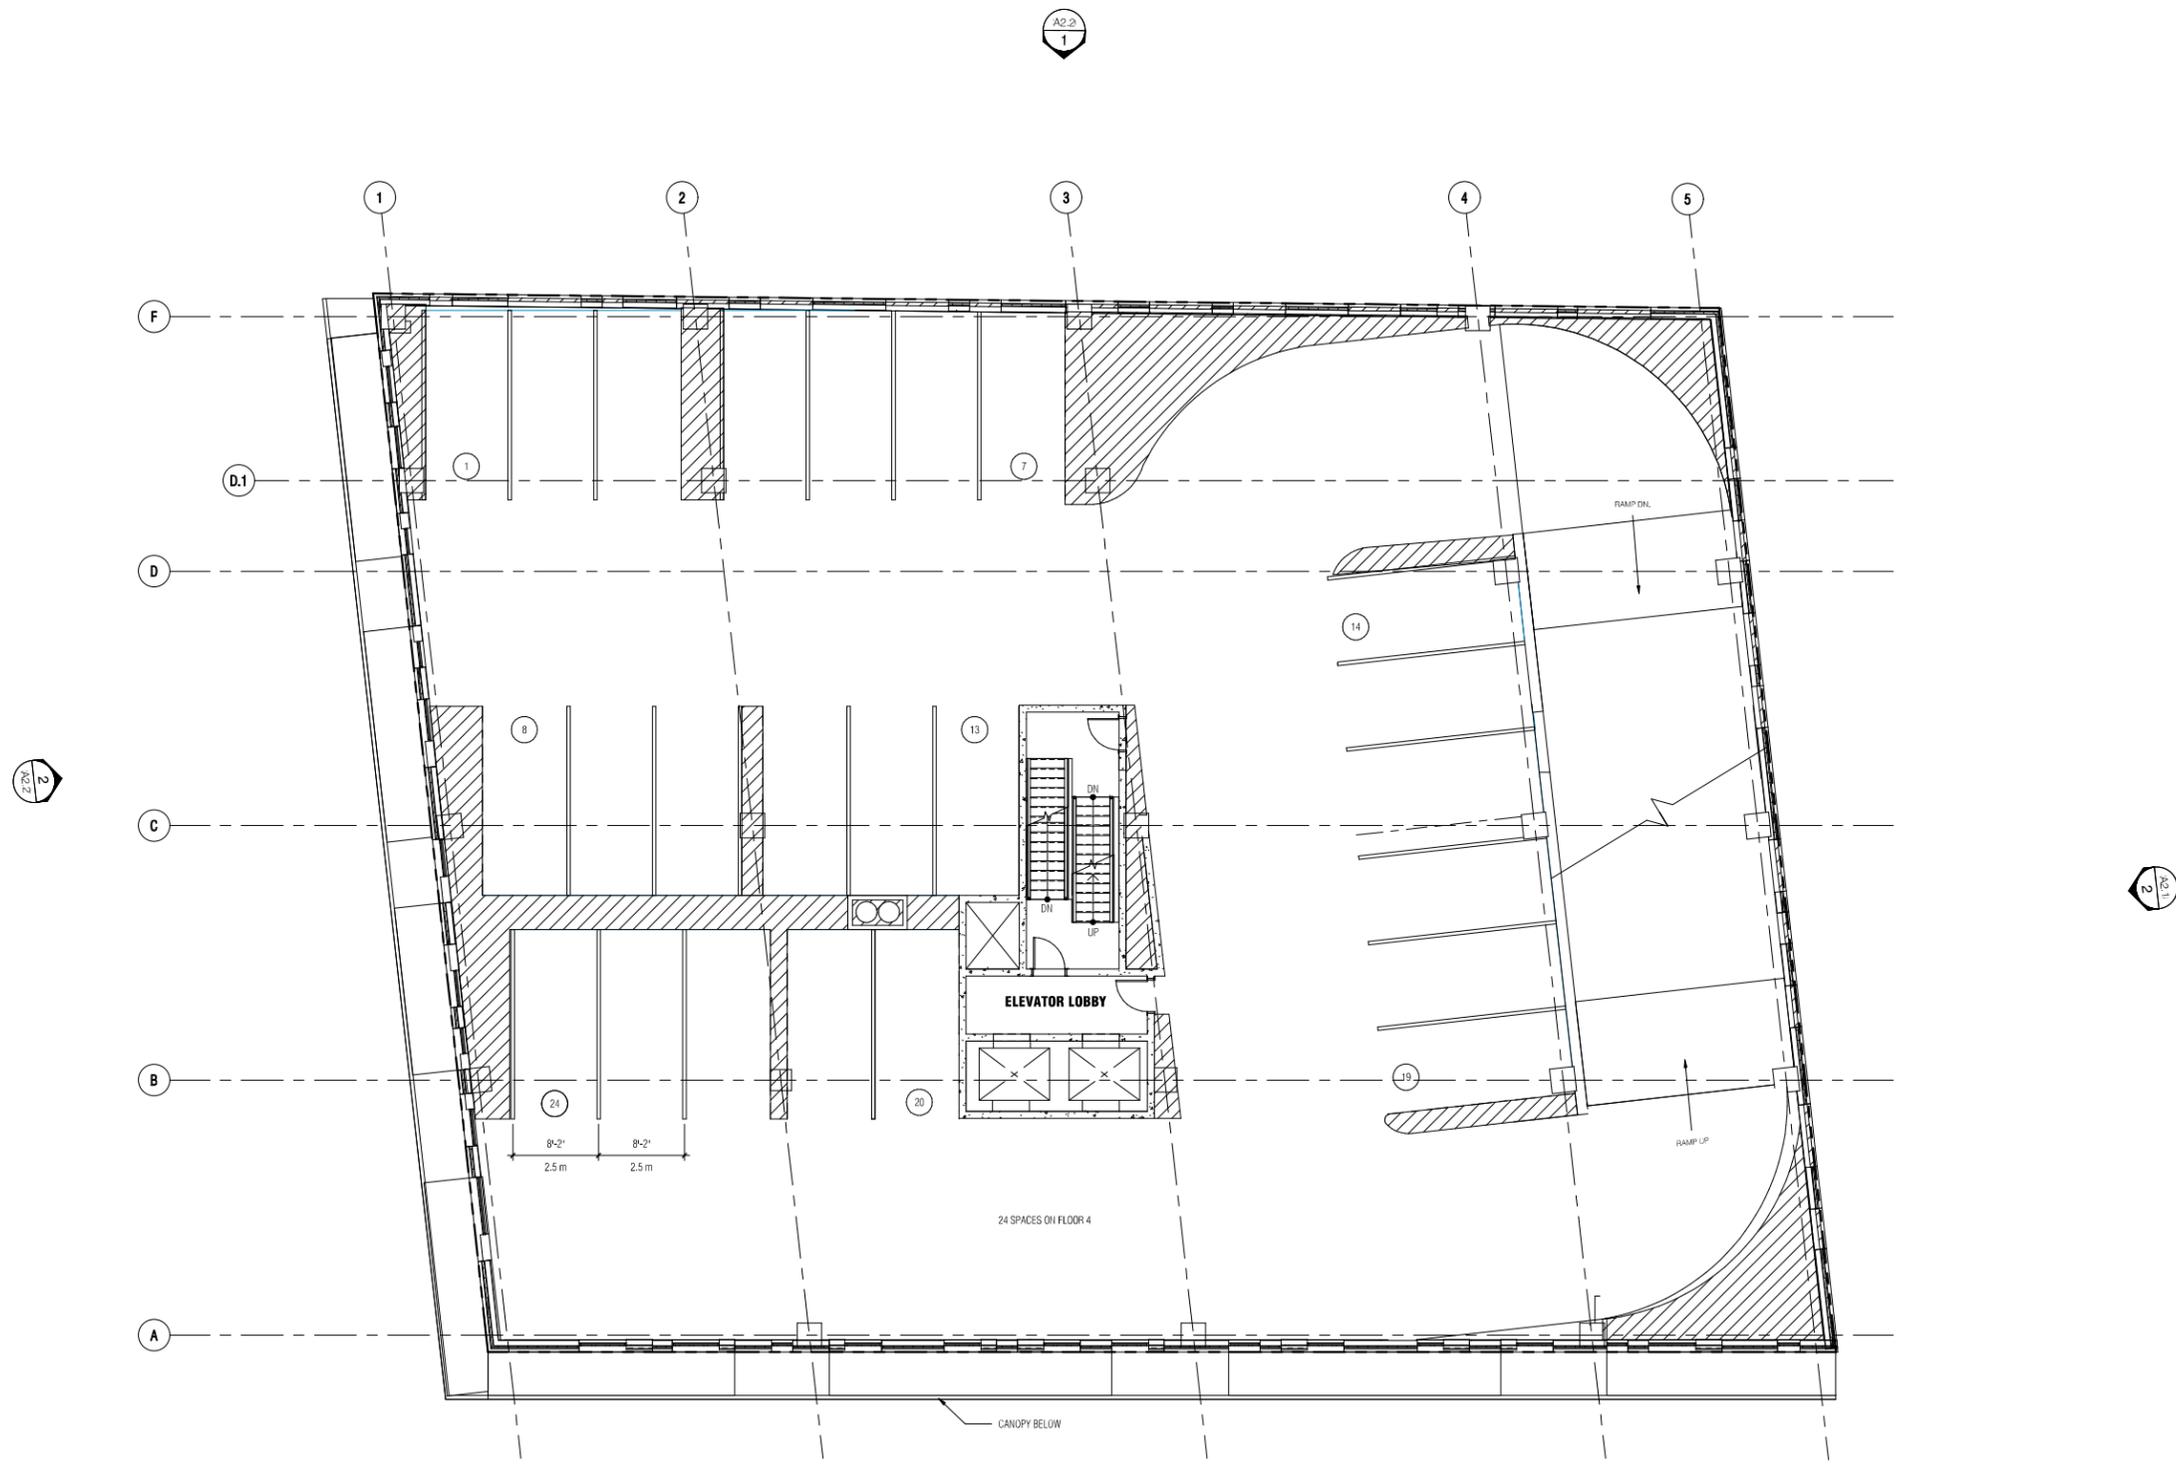
**PROJECT TITLE**  
CHATHAM ST. WEST CONDOS  
696 CHATHAM ST. WEST, WINDSOR ONTARIO

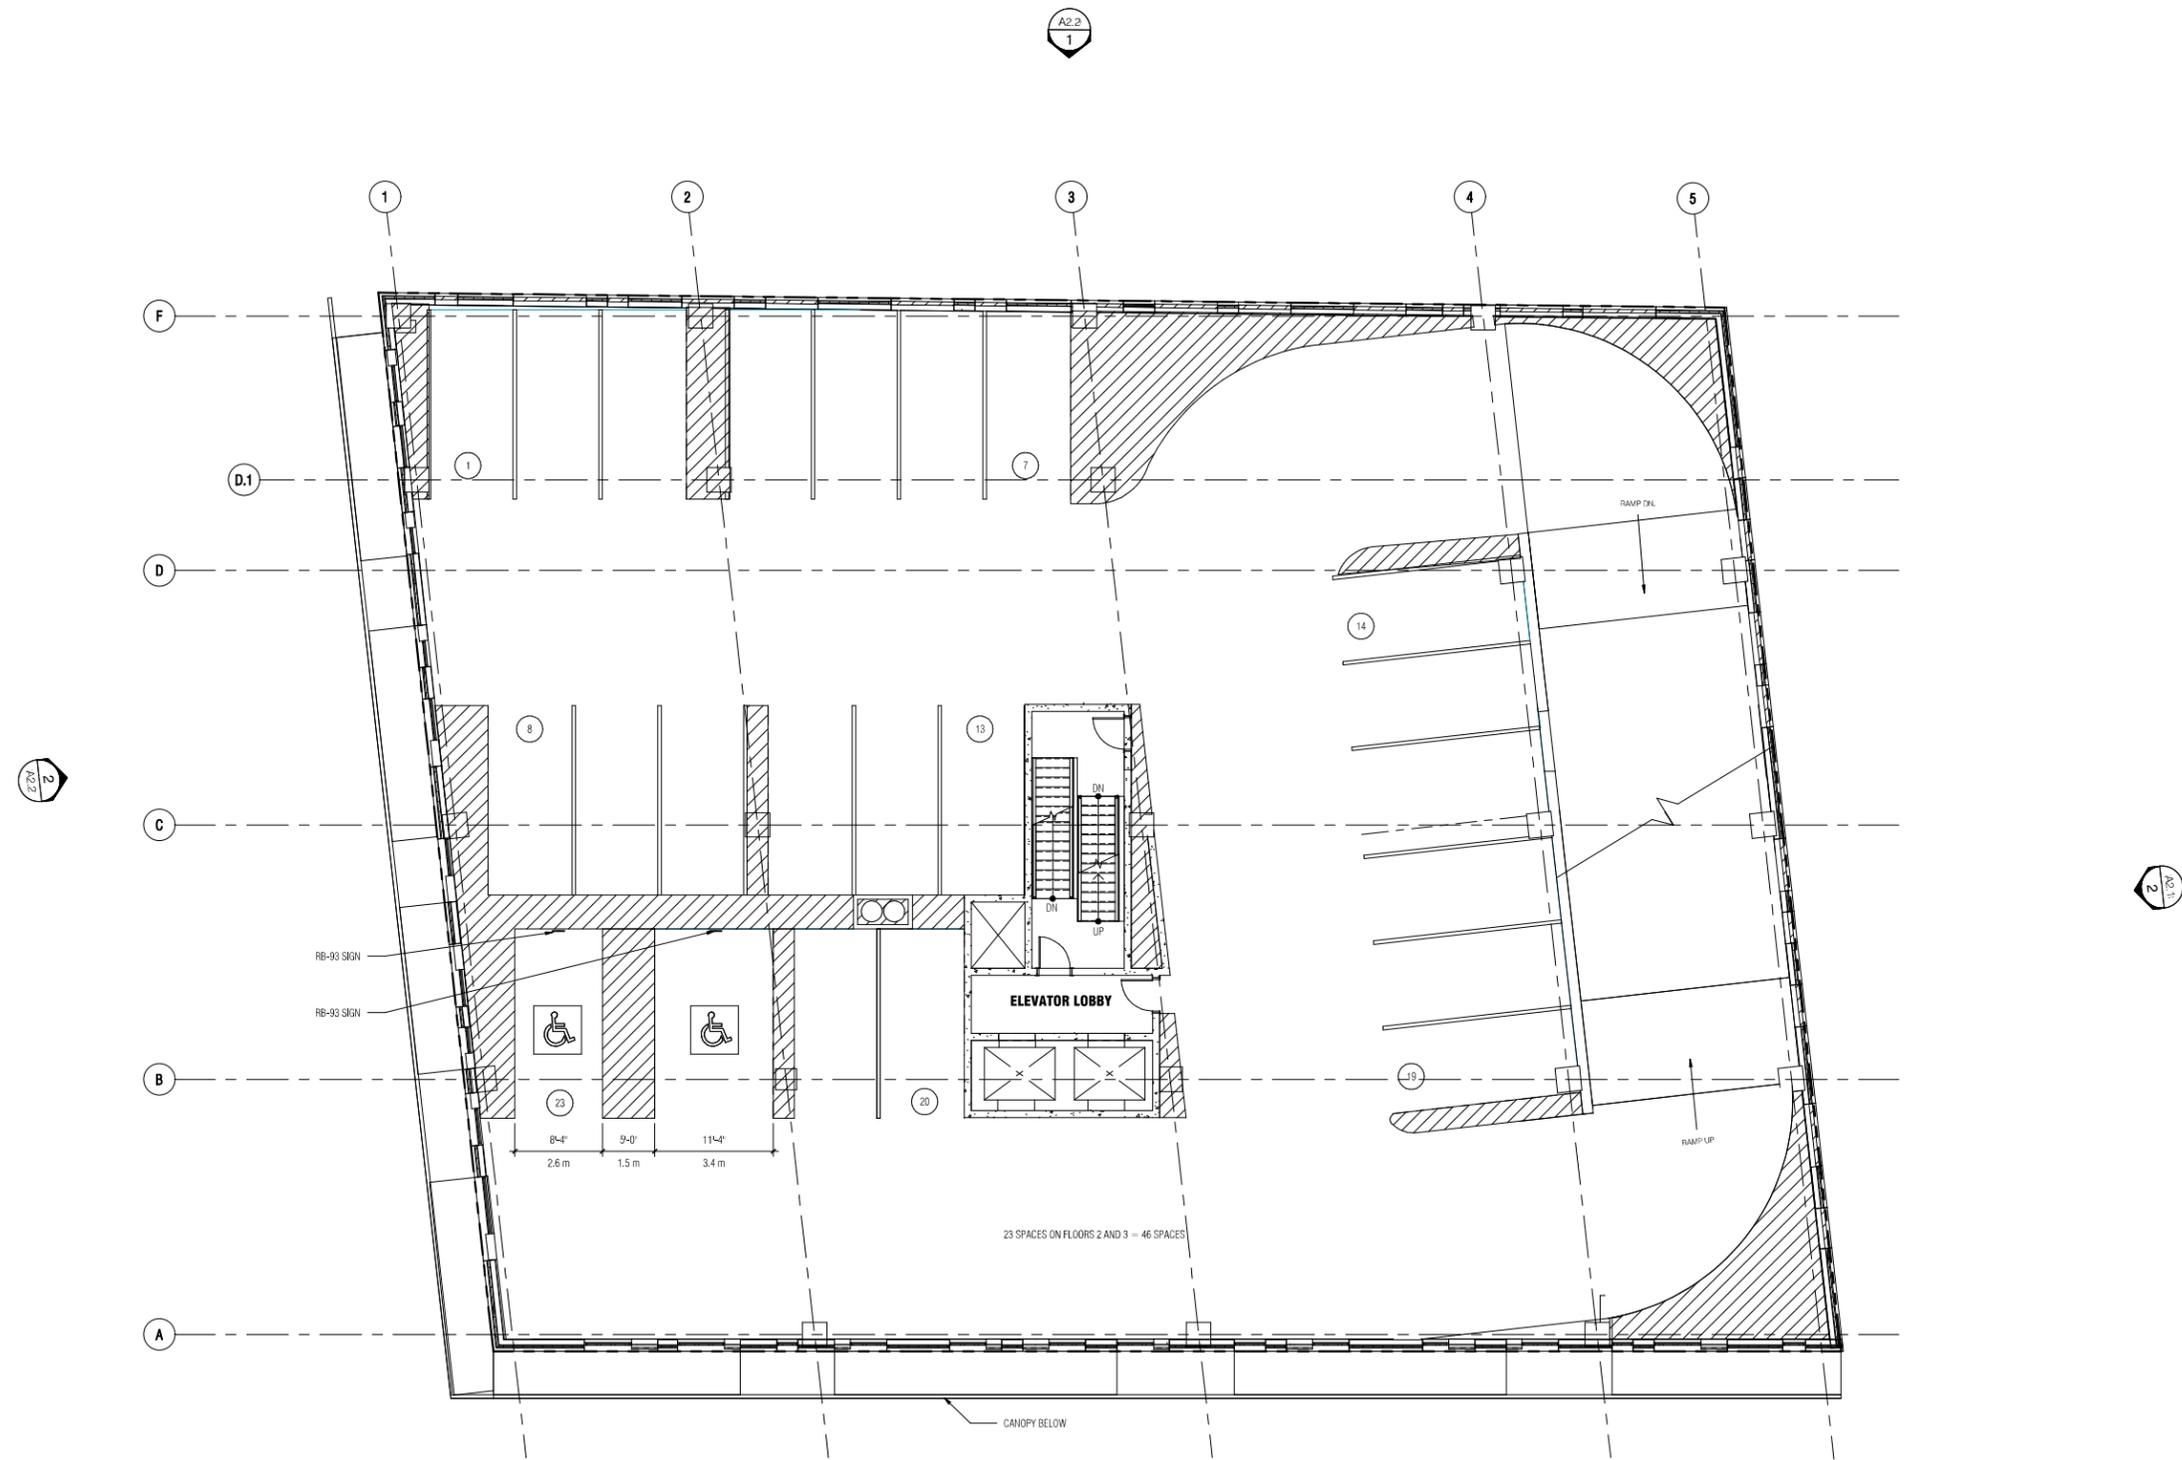**SHEET NUMBER**  
21-170

**DATE**  
1/20/23 9:27:00 AM

**PROJECT TITLE**  
CONCEPT 2ND & 3RD FLOOR

C:\Users\mkhobbs\OneDrive\Documents\CHatham St West Condos\CHatham St West Condos\_21-170.rvt



**FL 04**  
SCALE: 1/8" = 1'-0"


NO.	DESCRIPTION	DATE
ISSUE		

Drawn	<b>MK</b>	PRELIMINARY
Checked	<b>PW</b>	CONSTRUCTION
Approved	<b>PW</b>	RECORD
<b>PW</b>		Do not scale Use figured dimensions only

PROJECT TITLE	<b>CHATHAM ST. WEST CONDOS</b>
JOB NUMBER	696 CHATHAM ST. WEST, WINDSOR ONTARIO
SHEET NUMBER	<b>CONCEPT 4TH FLOOR</b>

PROJECT TITLE	<b>CHATHAM ST. WEST CONDOS</b>
JOB NUMBER	696 CHATHAM ST. WEST, WINDSOR ONTARIO
SHEET NUMBER	<b>CONCEPT 4TH FLOOR</b>
SHEET NUMBER	<b>A1.3</b>
DATE	1/20/2019 2:01:01 AM

C:\Users\mchadwick\OneDrive\Documents\CH17\Chatham St West Condos\4th floor

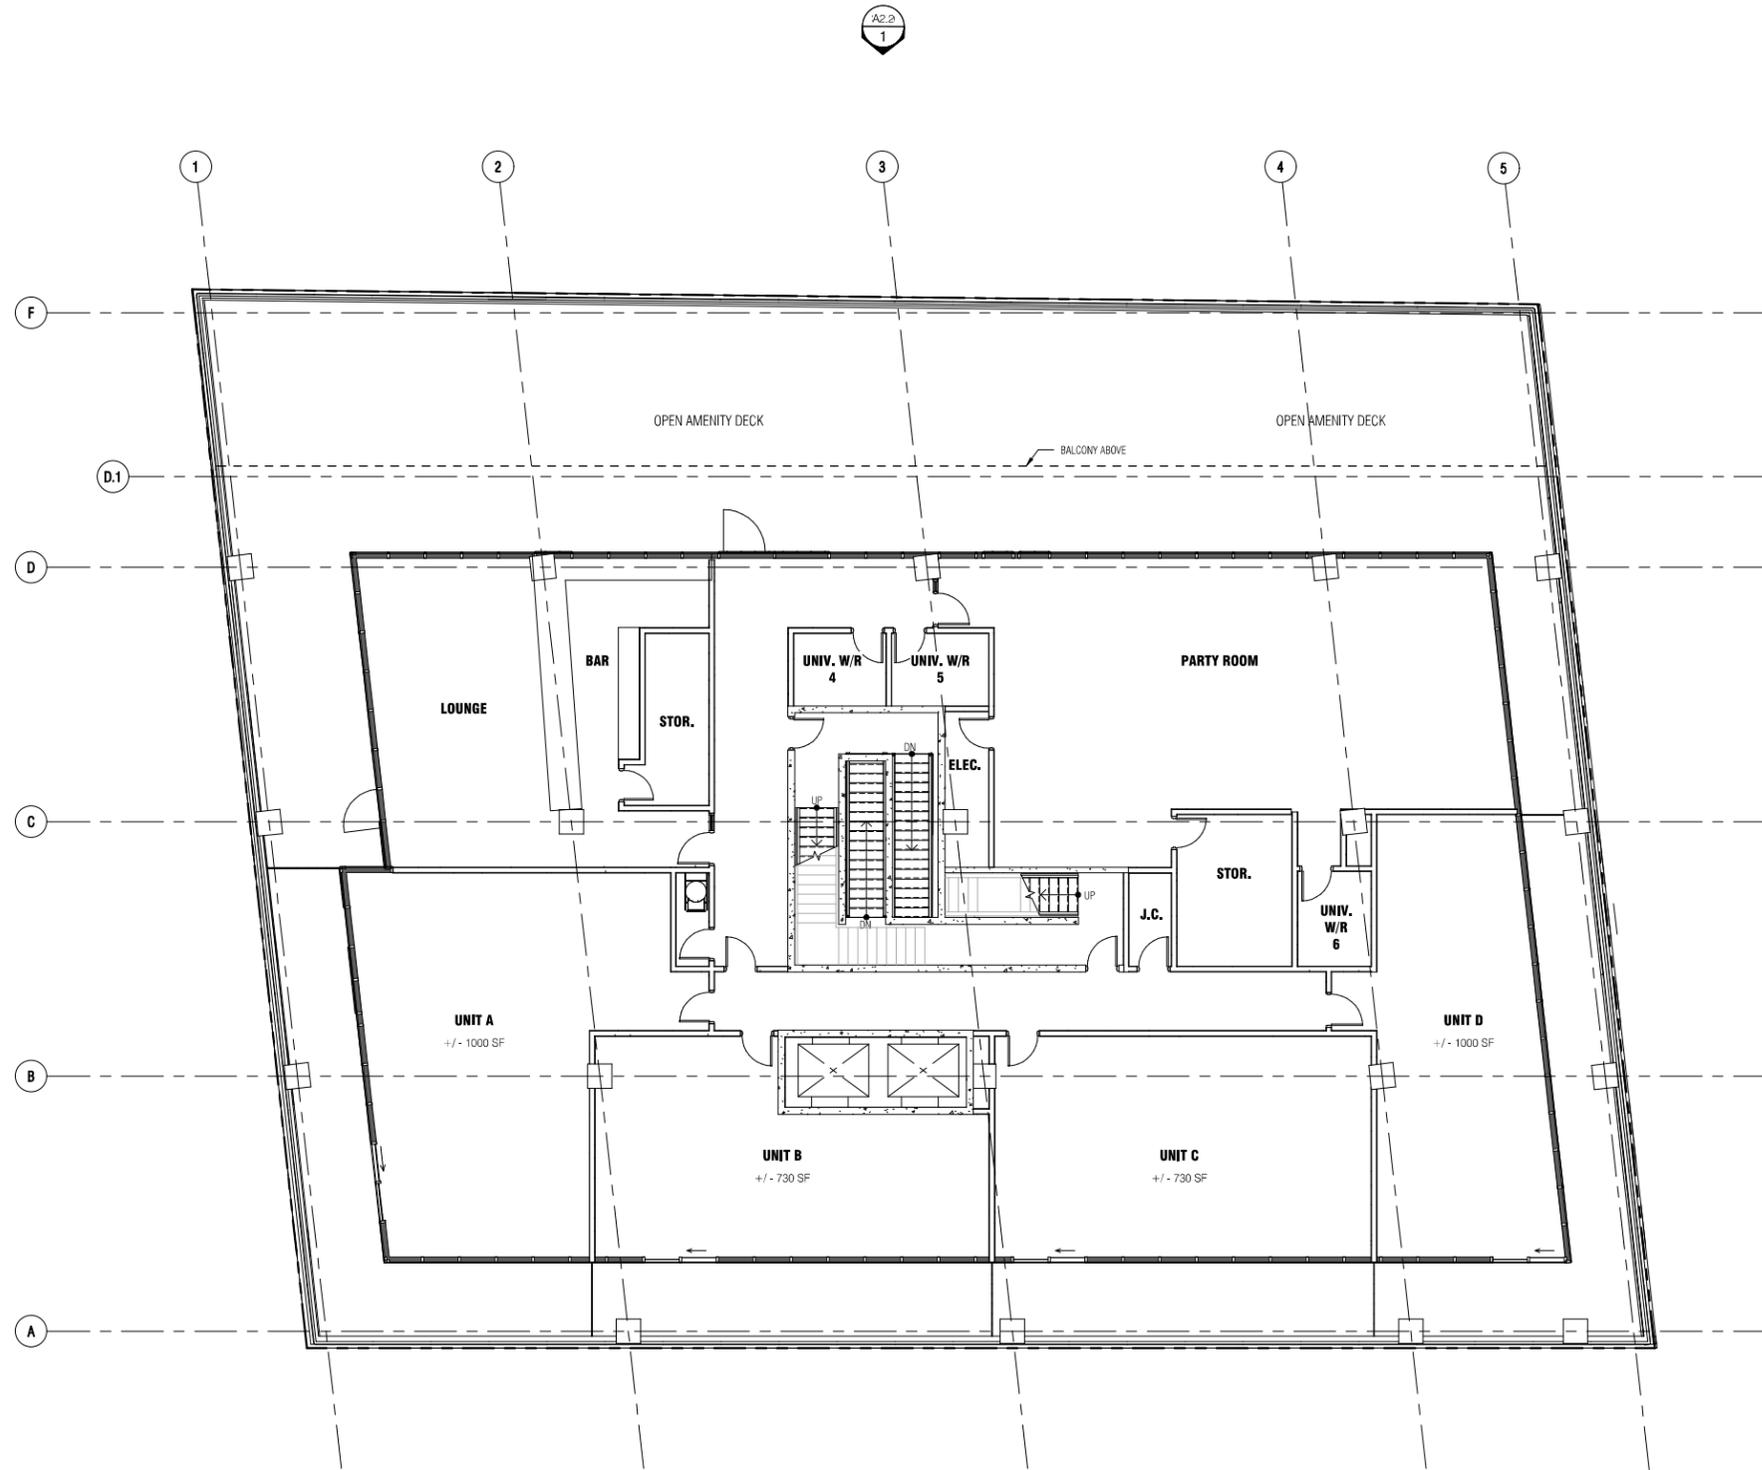

**FL-05**  
SCALE: 1/8" = 1'-0"

NO.	DESCRIPTION	DATE
	ISSUE	

<b>MK</b> Checked <b>PW</b> Approved <b>PW</b>	<input checked="" type="checkbox"/> PRELIMINARY <input type="checkbox"/> CONSTRUCTION <input type="checkbox"/> RECORD <b>Do not scale</b> <small>Use figured dimensions only</small>
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**PROJECT TITLE**  
CHATHAM ST. WEST CONDOS  
696 CHATHAM ST. WEST, WINDSOR ONTARIO


**PROJECT**  
CONCEPT 5TH FLOOR

**JOB NUMBER**  
21-170

**SHEET NUMBER**  
A1.4

1/20/2023 9:27:01 AM

C:\Users\matt\OneDrive - BAIRD | AE\Documents\21-170\Chatham St West\5th Floor\5th Floor.dwg

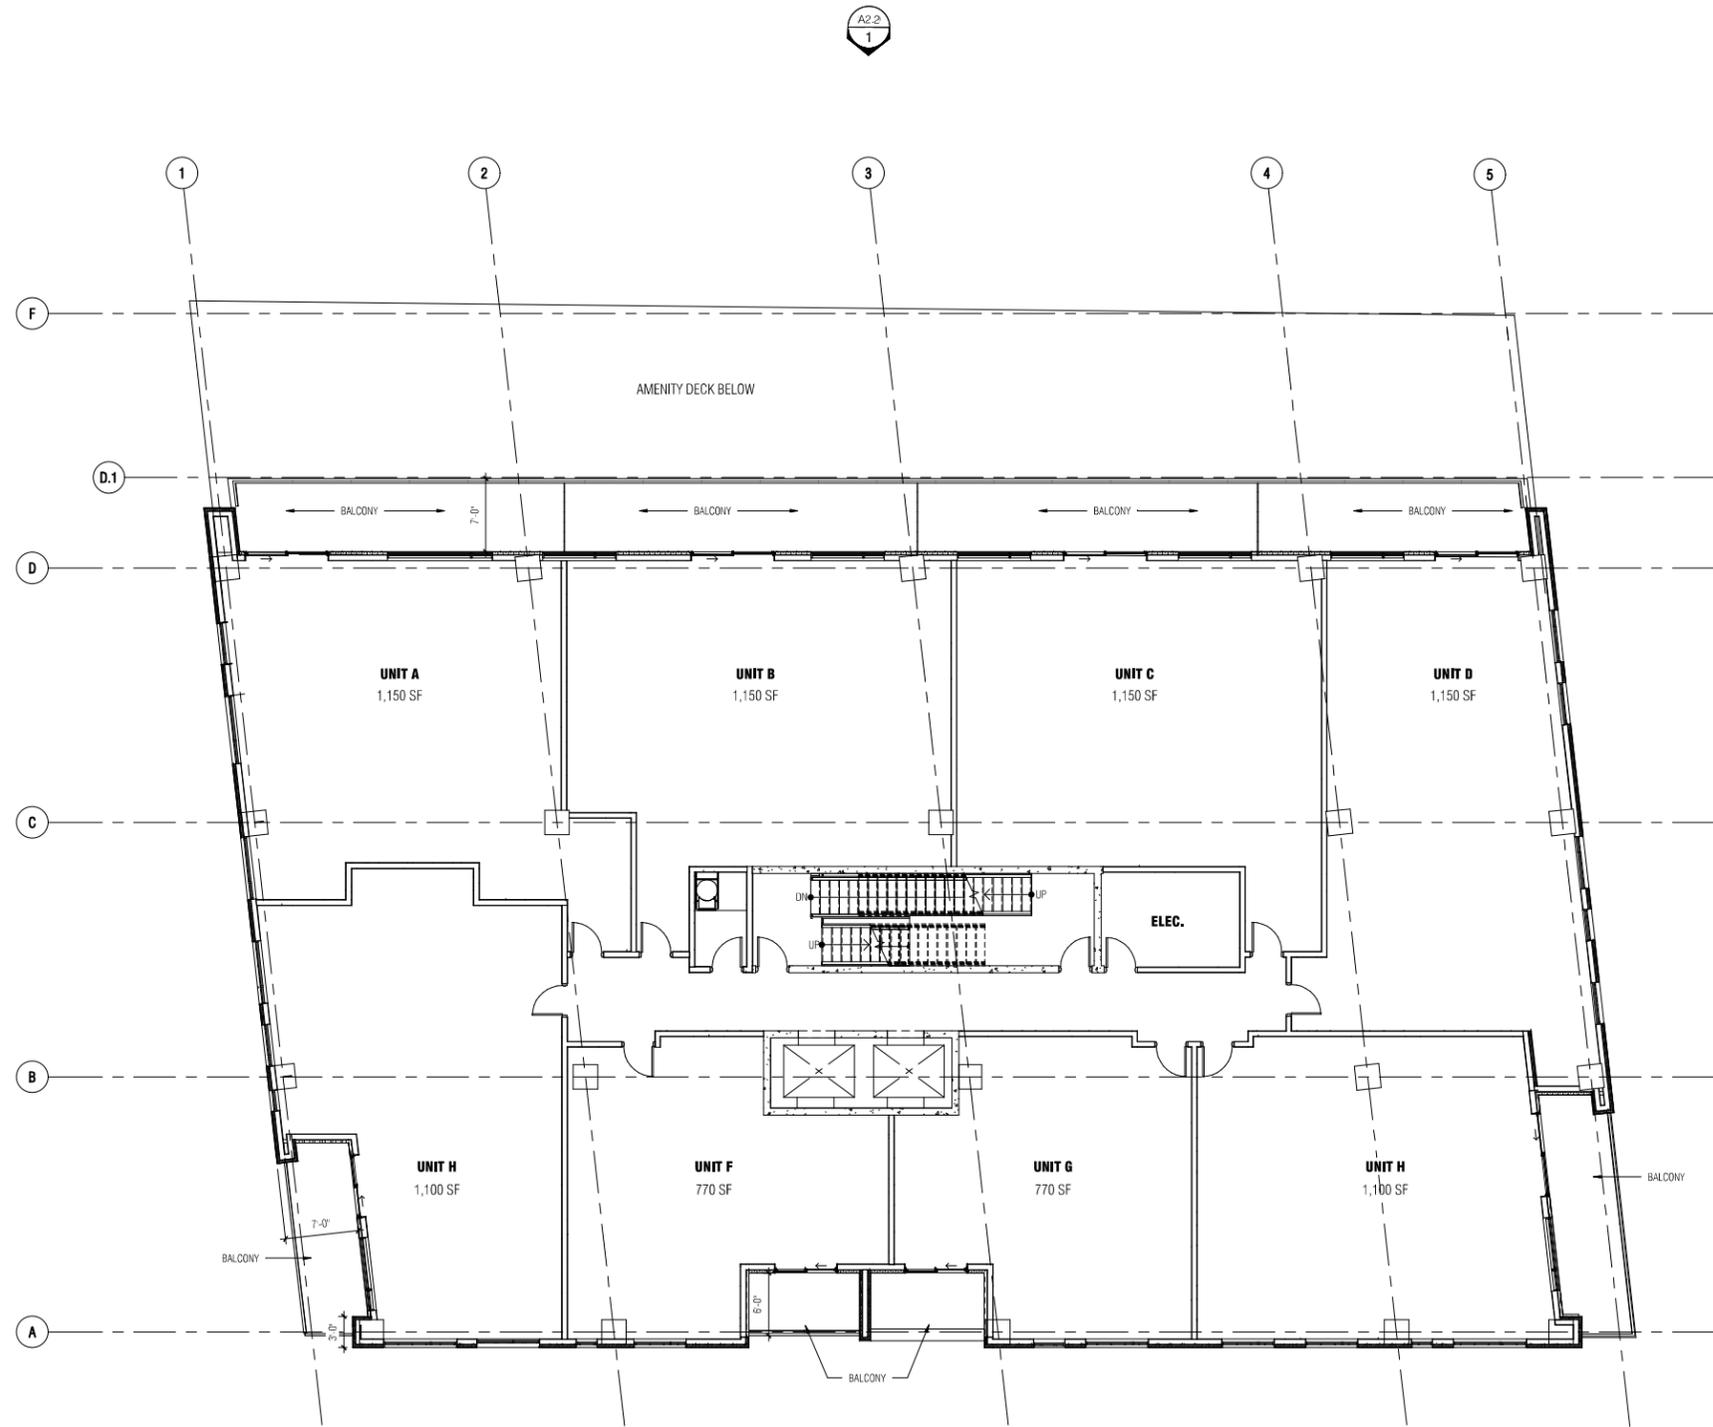

**FL 06 -14**  
SCALE: 1/8" = 1'-0"

NO.	DESCRIPTION	DATE
	ISSUE	

<p>Drawn: <b>MK</b></p> <p>Checked: <b>PW</b></p> <p>Approved: <b>PW</b></p>	<p><input checked="" type="checkbox"/> PRELIMINARY</p> <p><input type="checkbox"/> CONSTRUCTION</p> <p><input type="checkbox"/> RECORD</p> <p><b>Do not scale</b> Use figured dimensions only</p>
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**PROJECT TITLE**  
CHATHAM ST. WEST CONDOS  
696 CHATHAM ST. WEST, WINDSOR ONTARIO


**SHEET NUMBER**  
21-170

**SHEET NUMBER**  
**A1.5**

**DATE**  
1/20/23 9:27:52 AM

**PROJECT TITLE**  
CONCEPT 6TH - 14TH FLOOR

C:\Users\mshah\OneDrive - BAIRD|AE\Documents\CH14\Chatham St West\condos\general\14th floor.dwg

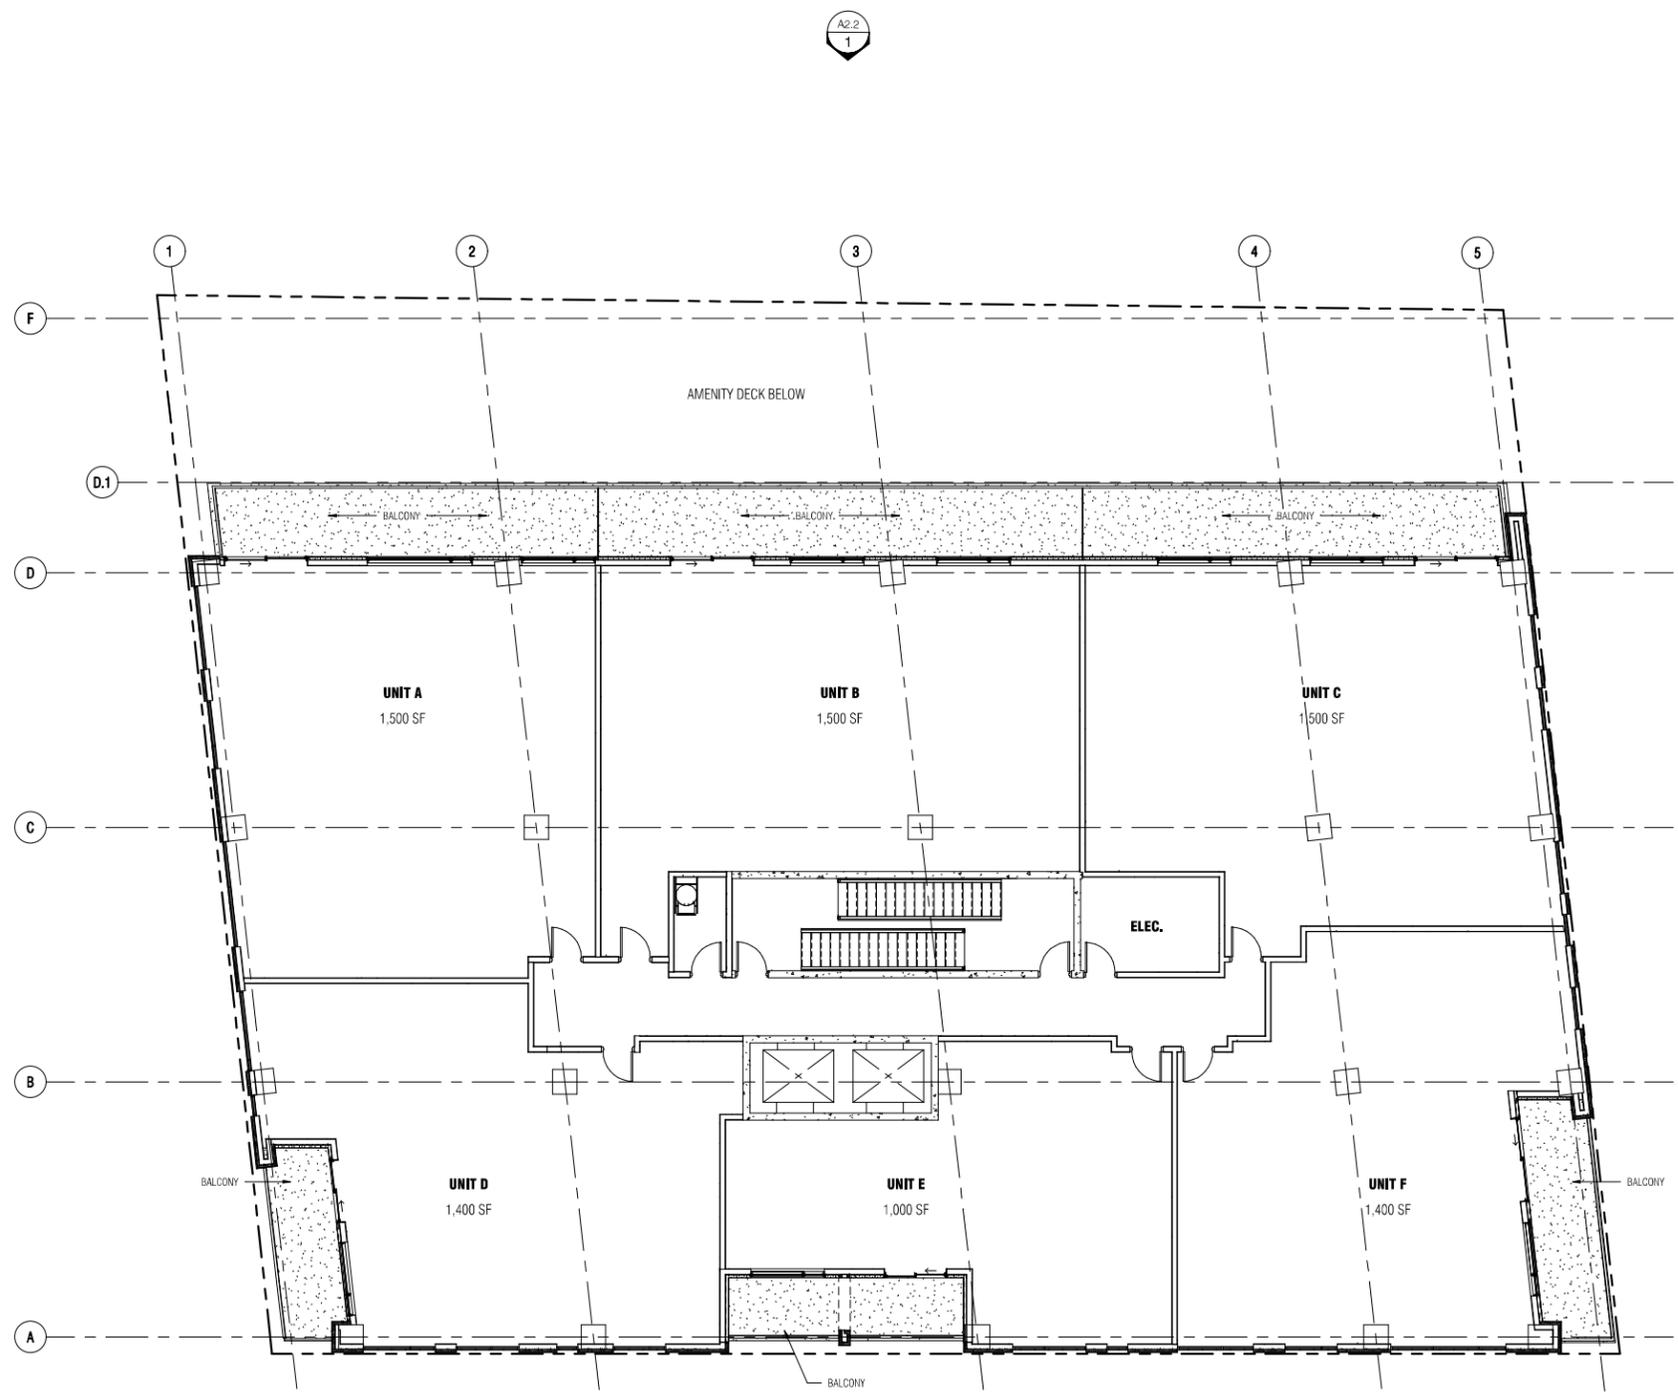

**FL 15 -16**  
SCALE: 1/8" = 1'-0"

NO.	DESCRIPTION	DATE
	ISSUE	

--

<b>MK</b>	PREPARED
Checked	CONSTRUCTION
<b>PW</b>	RECORD
Approved	<b>Do not scale</b> Use figured dimensions only

**PROJECT TITLE**  
**CHATHAM ST. WEST CONDOS**  
696 CHATHAM ST. WEST, WINDSOR ONTARIO

**SHEET TITLE**  
**CONCEPT 15TH & 16TH FLOOR**

**SHEET NUMBER**  
21-170

**PROJECT NUMBER**  
**A1.6**

1/20/2023 9:27:52 AM

C:\Users\matt\Documents\CH15\Chatham St West\Concept 15th & 16th Floor

NO.	DESCRIPTION	DATE
ISSUE		

BS	FILE HISTORY
Check	CONSTRUCTION
PW	RECORD
Approved	Do not scale Use figure dimensions only


**PROJECT TITLE**  
**CHATHAM ST. WEST CONDOS**  
 696 CHATHAM ST. WEST, WINDSOR ONTARIO

**PROJECT NUMBER**  
 21-170


**DATE**  
 1/20/23 9:27:02 AM

**CONCEPT ELEVATIONS**


**A2.1**

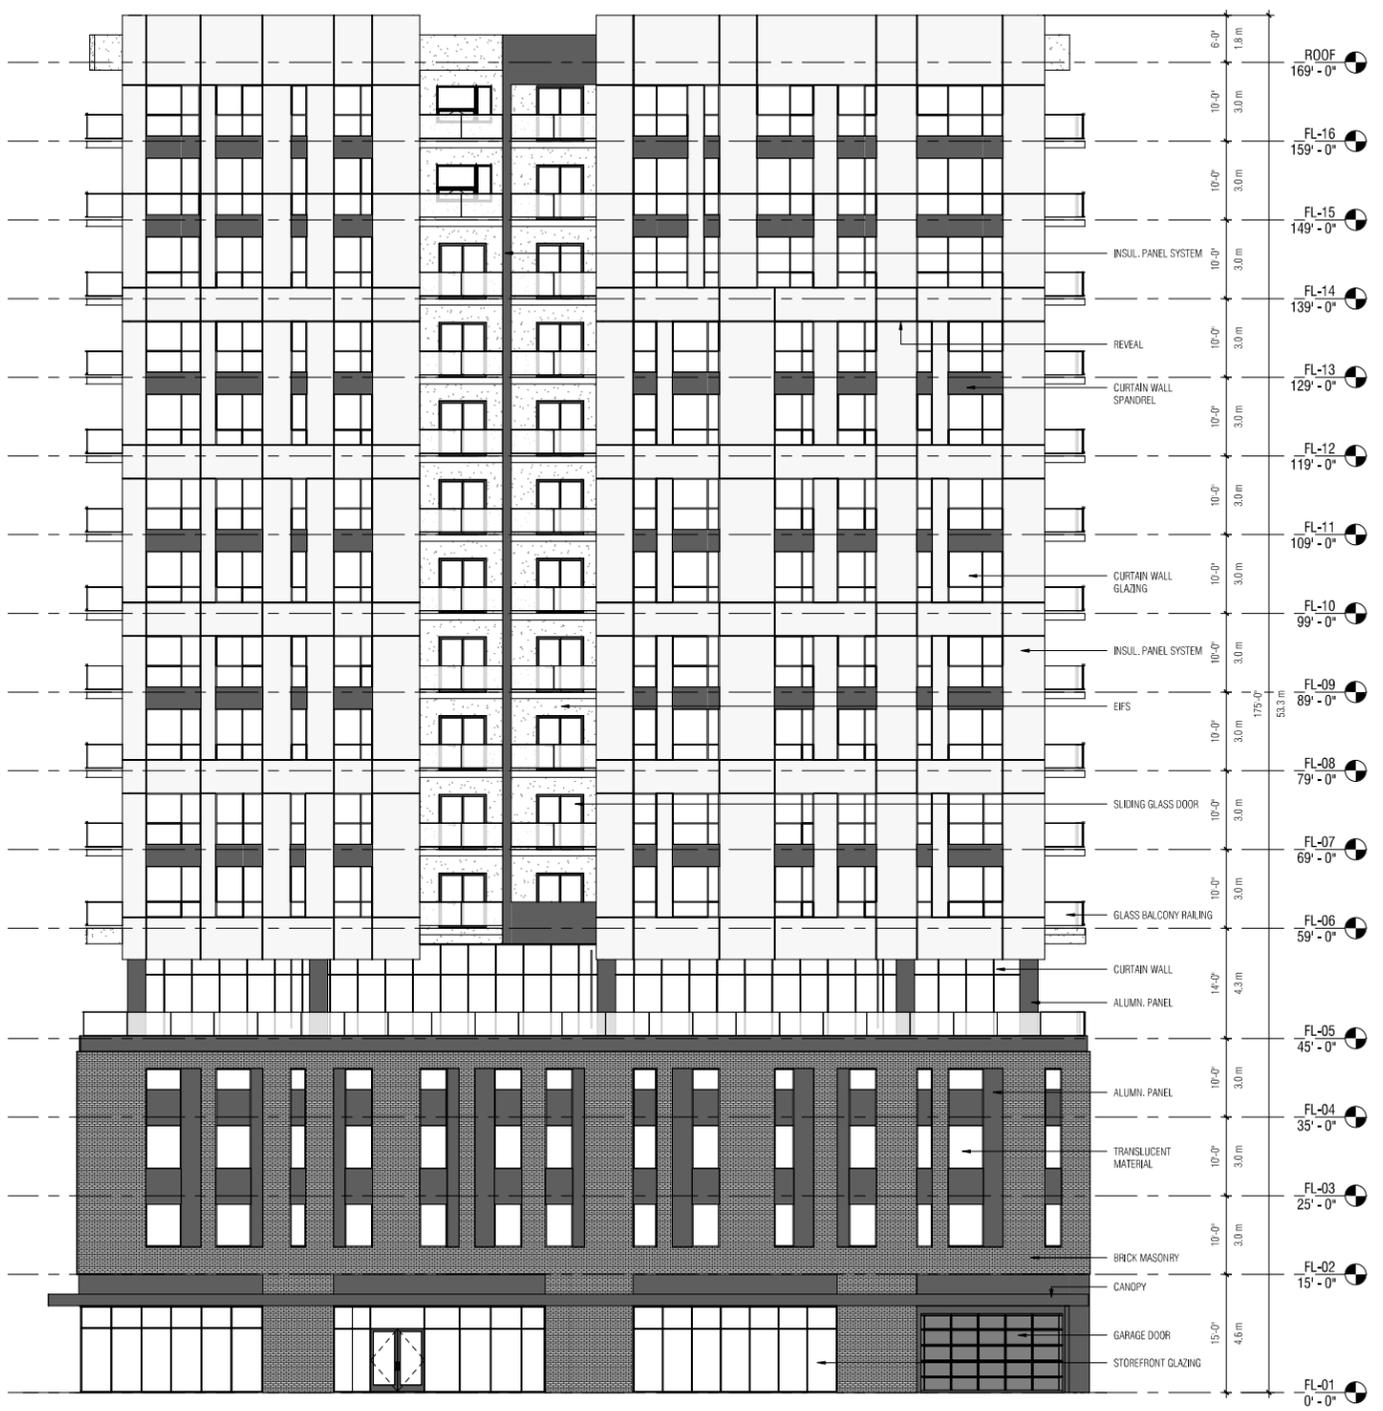


**1 NORTH ELEVATION**  
 3/32" = 1'-0"

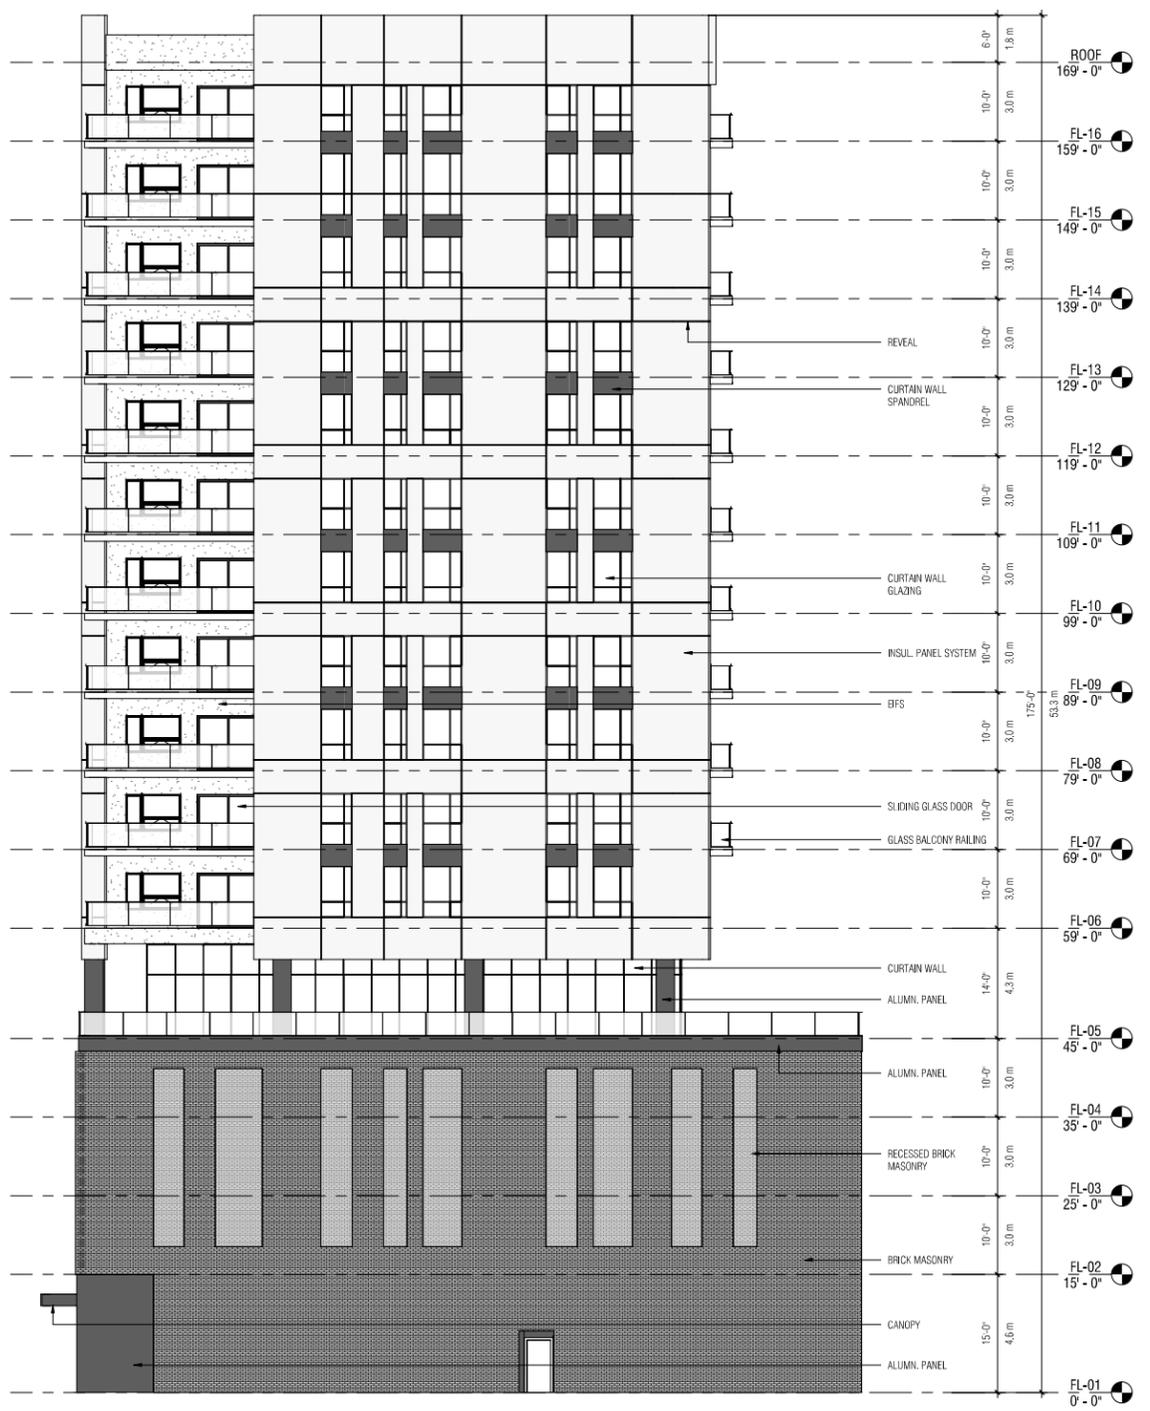

**2 WEST ELEVATION**  
 3/32" = 1'-0"

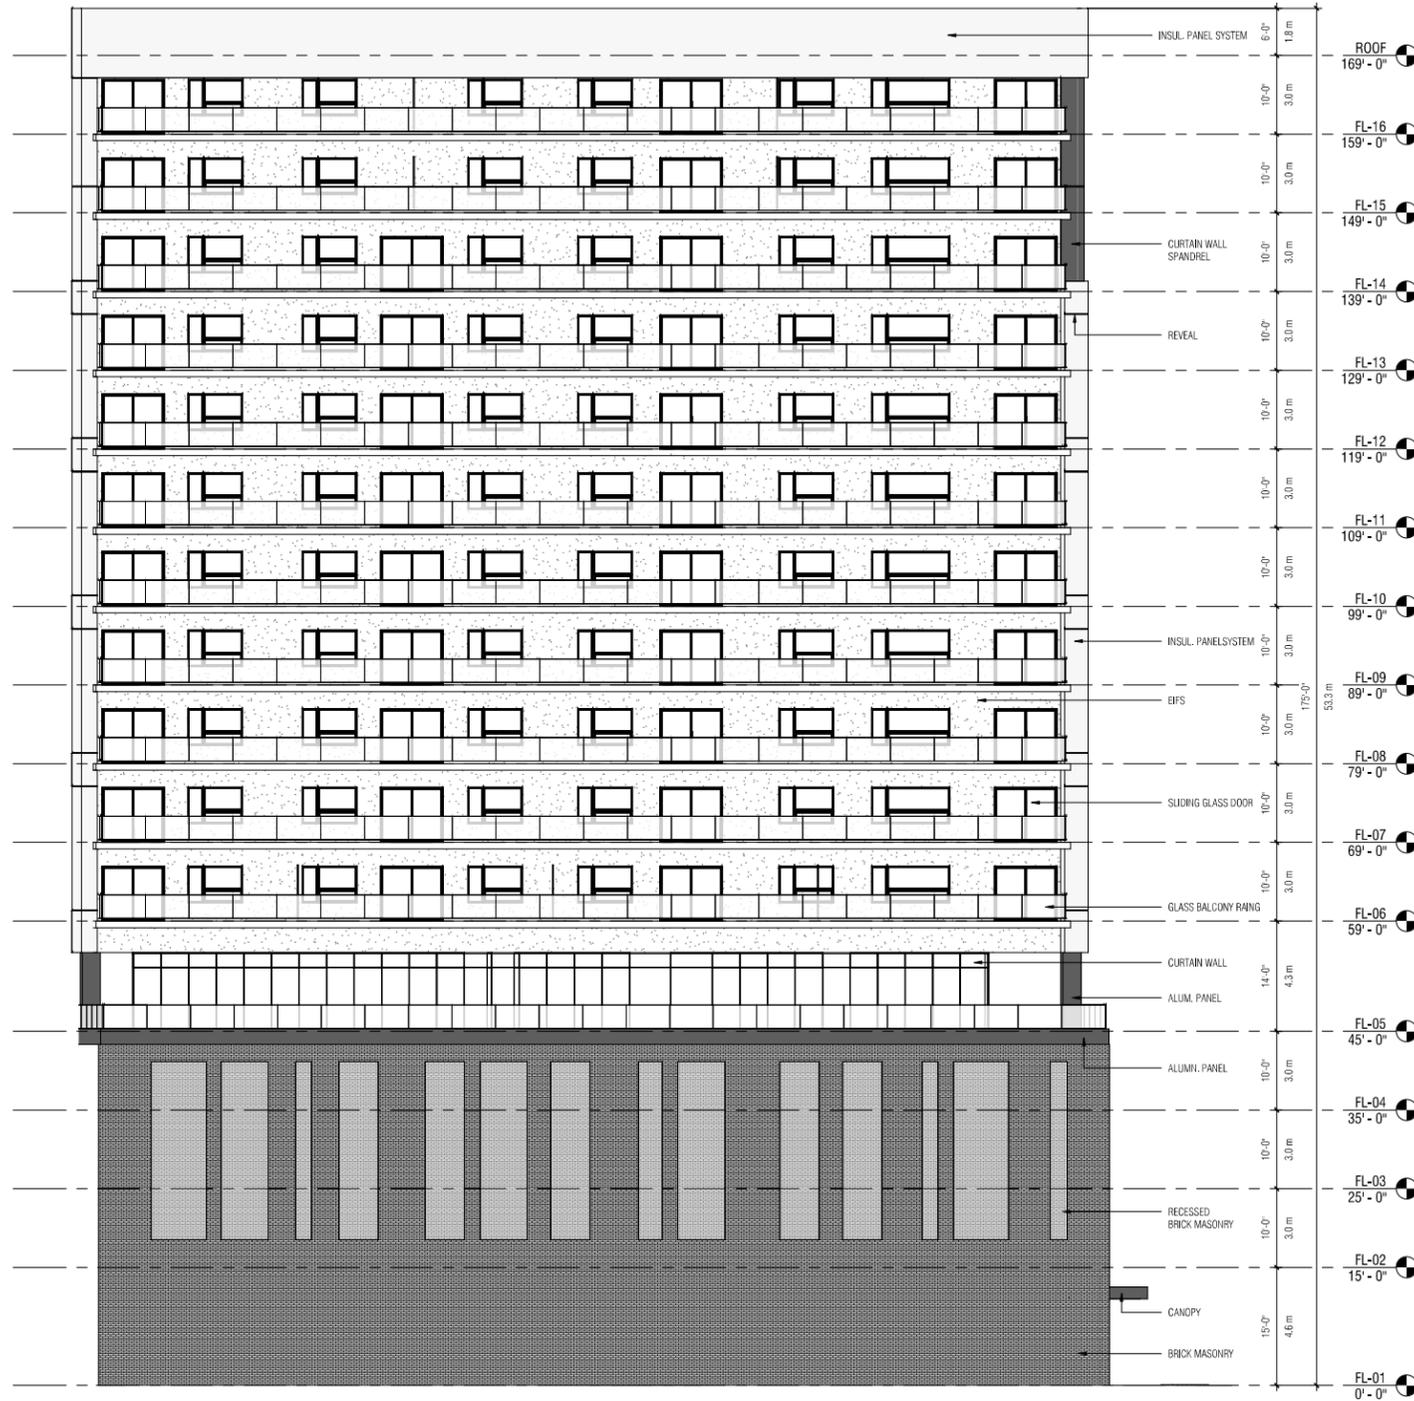

1 SOUTH ELEVATION  
1/8" = 1'-0"

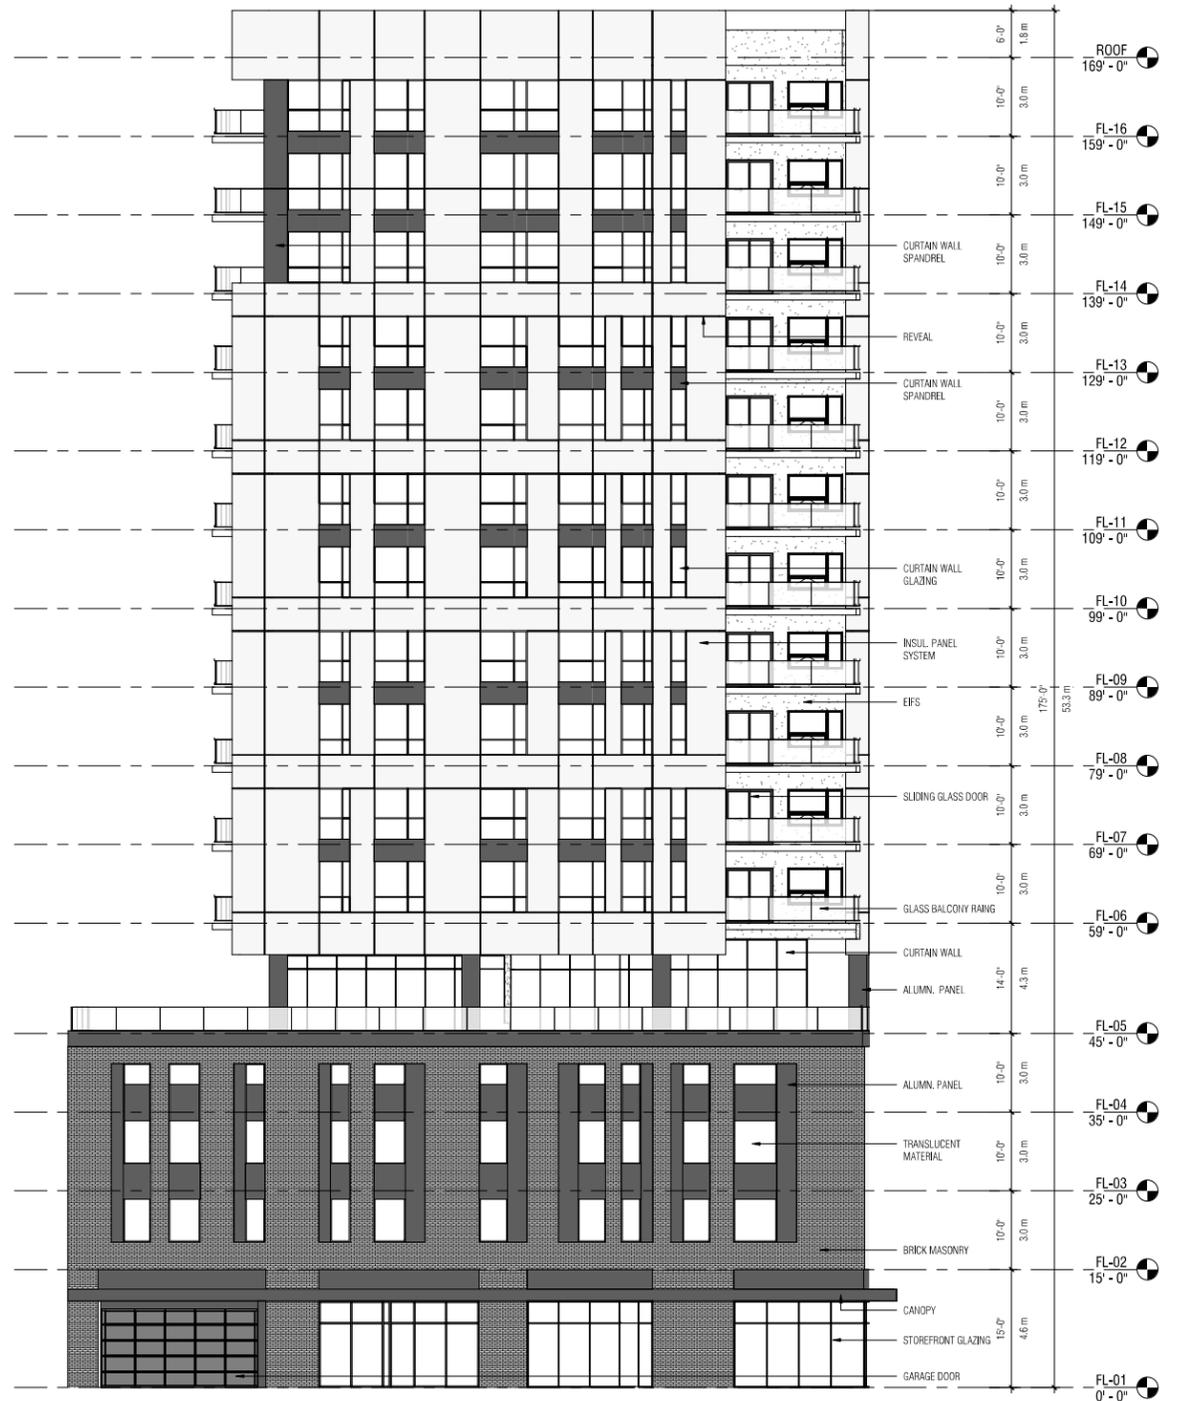

2 EAST ELEVATION  
1/8" = 1'-0"

NO.	DESCRIPTION	DATE
	ISSUE	

BS	PRELIMINARY
Check	CONSTRUCTION
PW	RECORD
Approved	Do not scale Use figure dimensions only
PW	



**Noise Level - Assumption**

<b>Level</b>	<b>31</b>	<b>63</b>	<b>125</b>	<b>250</b>	<b>500</b>	<b>1000</b>	<b>2000</b>	<b>4000</b>	<b>8000</b>
<b>Rail Yard and Locomotive</b>									
Locomotive – Diesel	0.00	74.2	76.2	86.2	93.2	99.2	98.2	96.2	89.2
Hand-Held Hydraulic Brake	0.00	79.03	88.13	101.63	107.03	111.23	110.43	107.23	109.13
Whistle	0.00	0.00	0.00	0.00	0.00	115.00	0.00	0.00	0.00
<b>Cars and Trucks</b>									
Light Vehicles 50km/h	57.92	63.92	67.02	73.26	80.53	88.48	86.65	79.26	69.12
Trucks - Diesel	0.00	71.20	81.20	83.20	85.20	86.20	82.20	78.20	72.20
Cars	0.00	64.20	71.20	83.20	76.20	79.20	79.20	73.20	66.0

## Appendix B

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### NOISE OUTPUT AND NOISE MONITORING

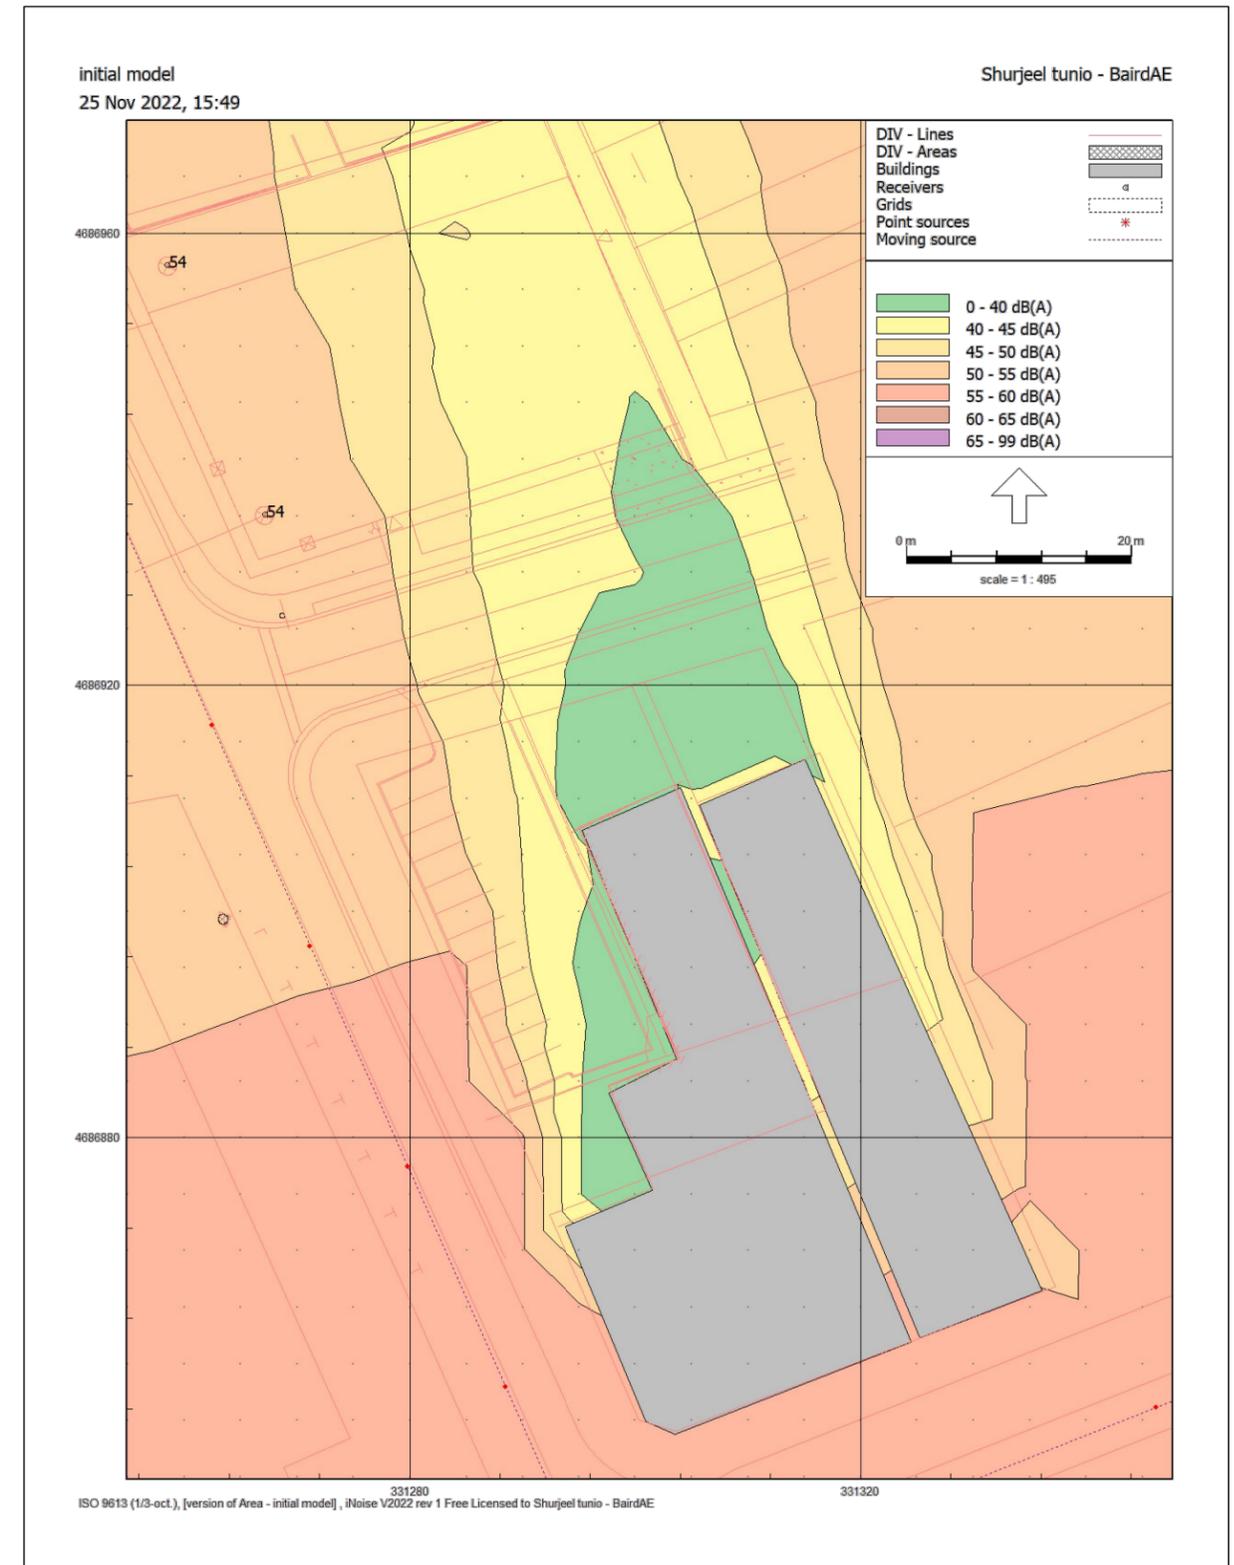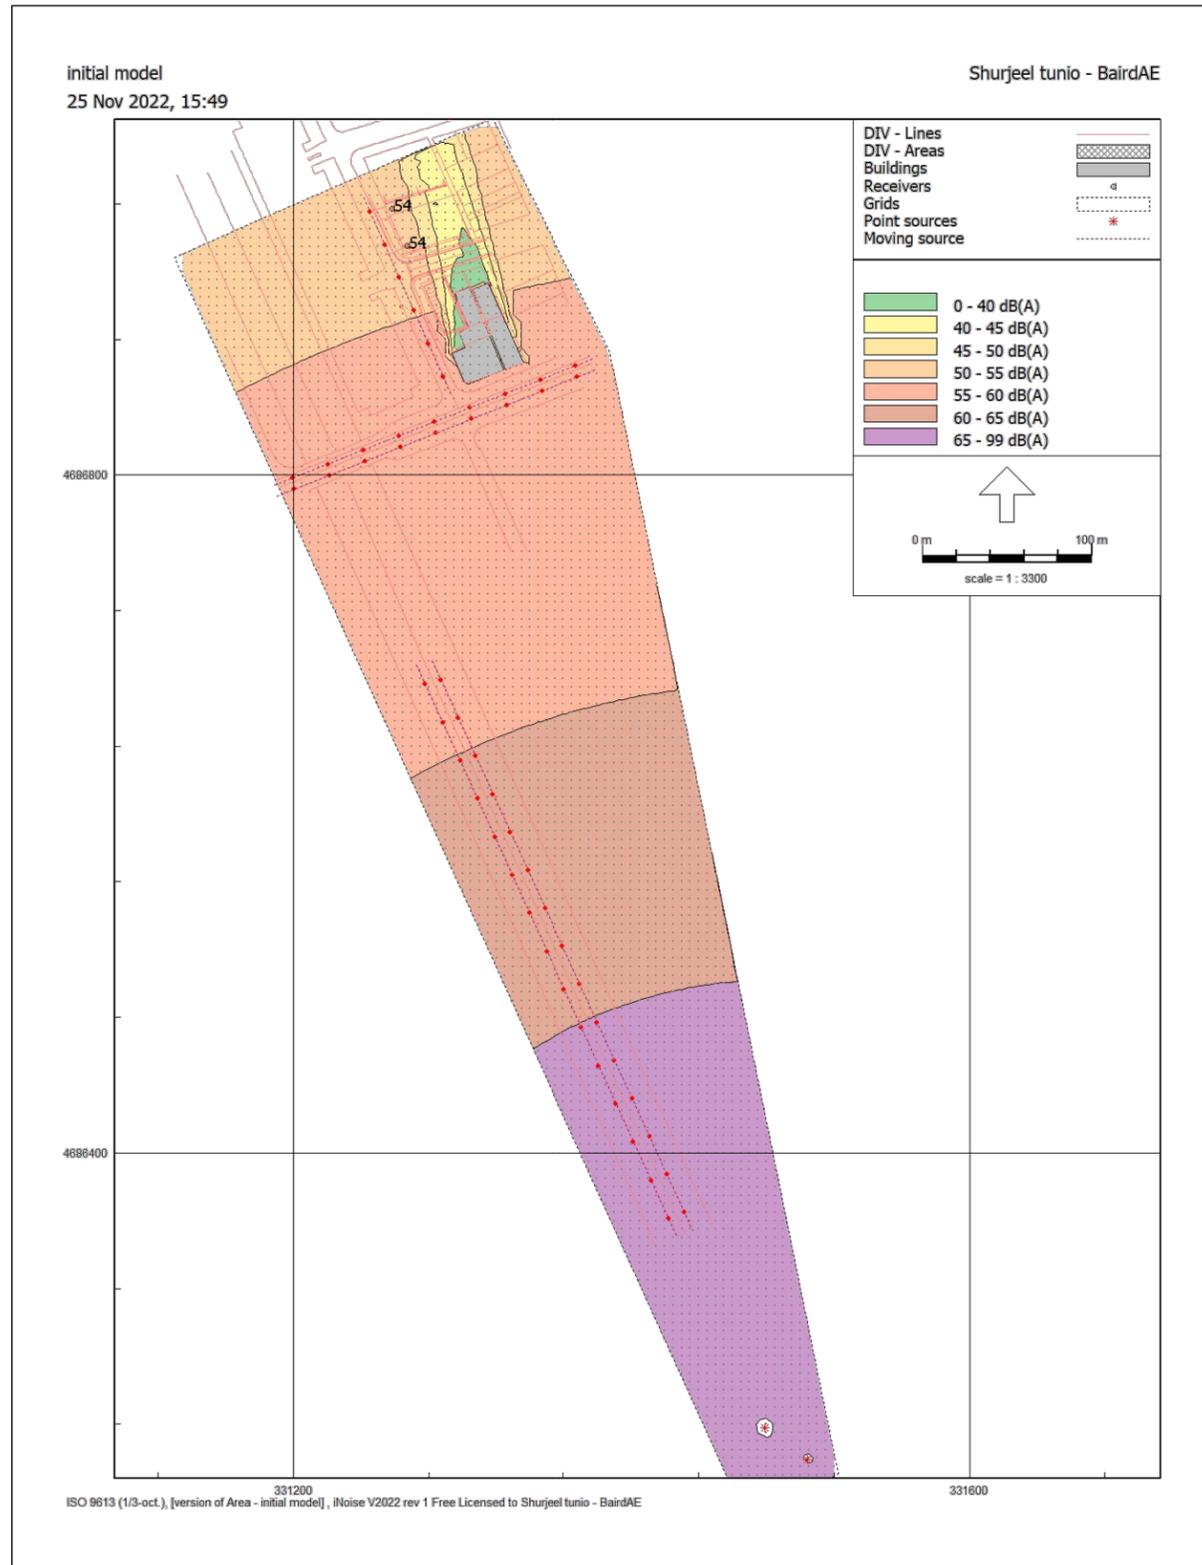

### LEGEND

- RECEIVER LOCATION
- PROPOSED DEVELOPMENT
- NOISE SOURCES



PROJECT TITLE:  
696 CHATHAM STREET WEST  
CITY OF WINDSOR  
WINDSOR, ON

SHEET TITLE:  
FIGURE 2 - PRE DEVELOPMENT NOISE LEVEL

DRAWN BY:  
S.T.



SCALE:  
NTS

DATE:  
NOV 22 2022

CHCKD BY:  
ST.

SHEET No. :  
2 OF 3

PROJECT No. :  
21-170

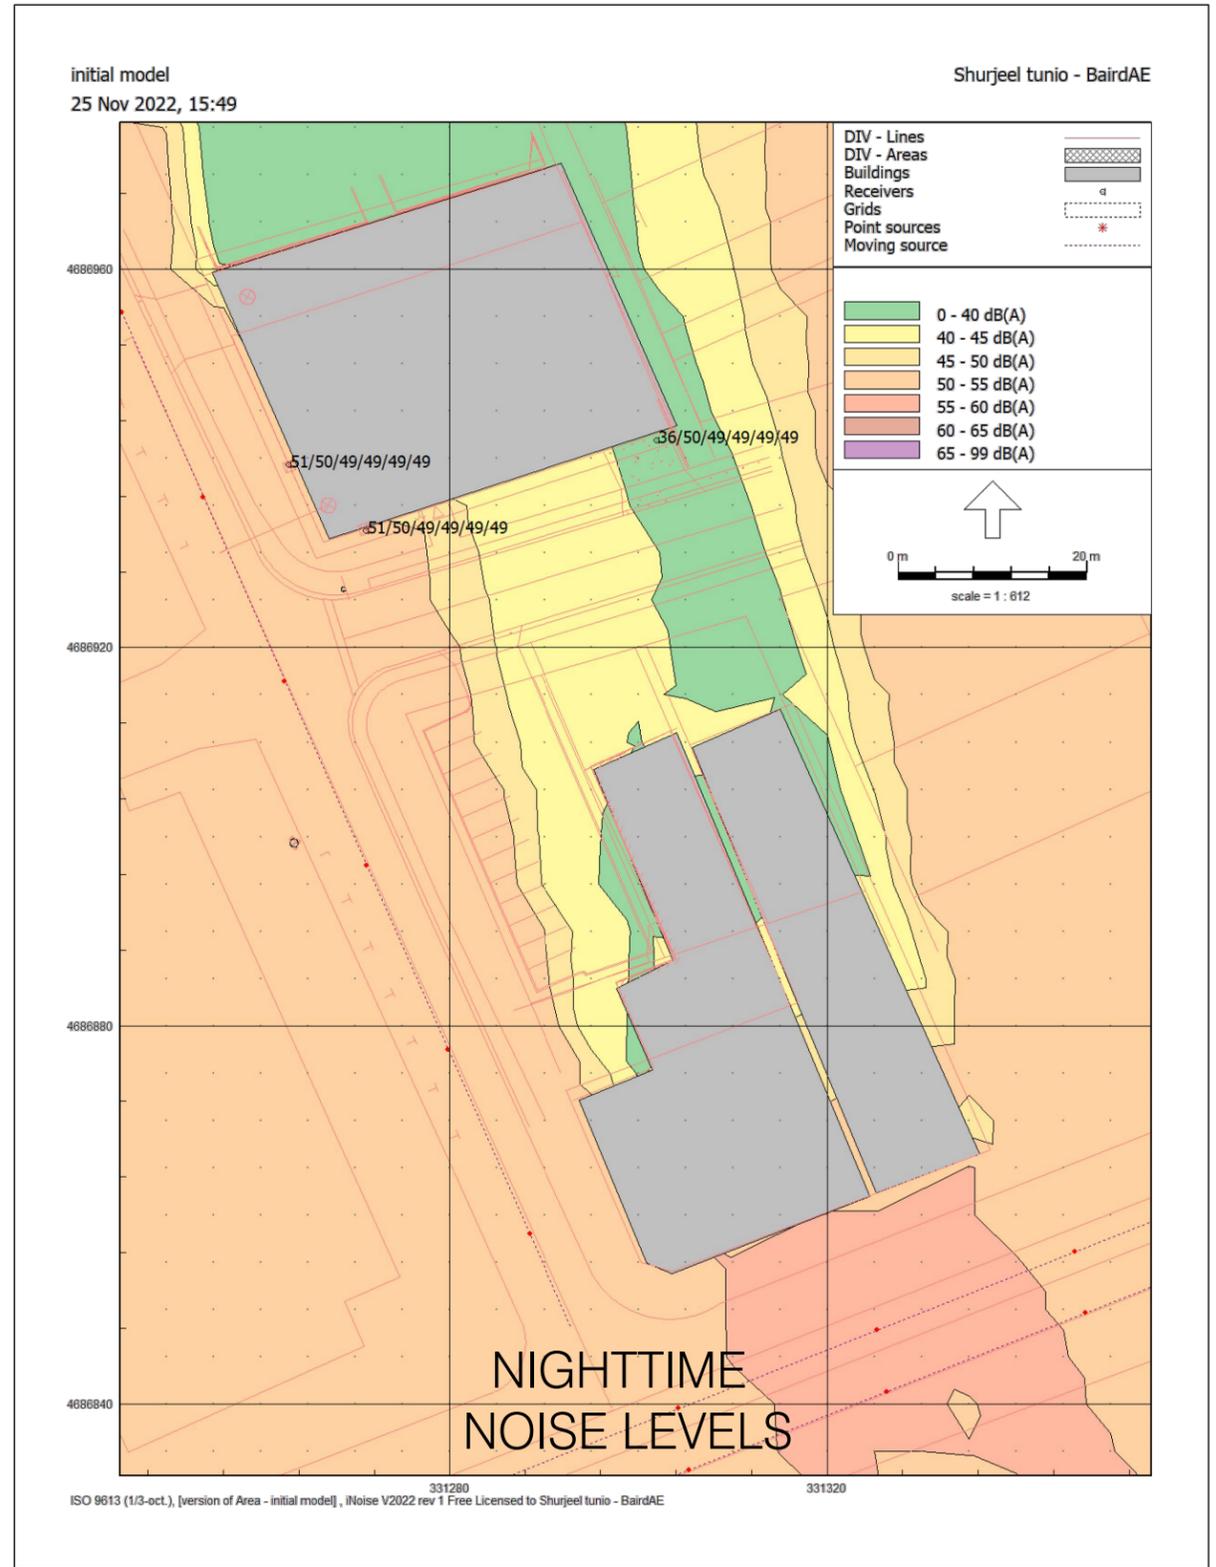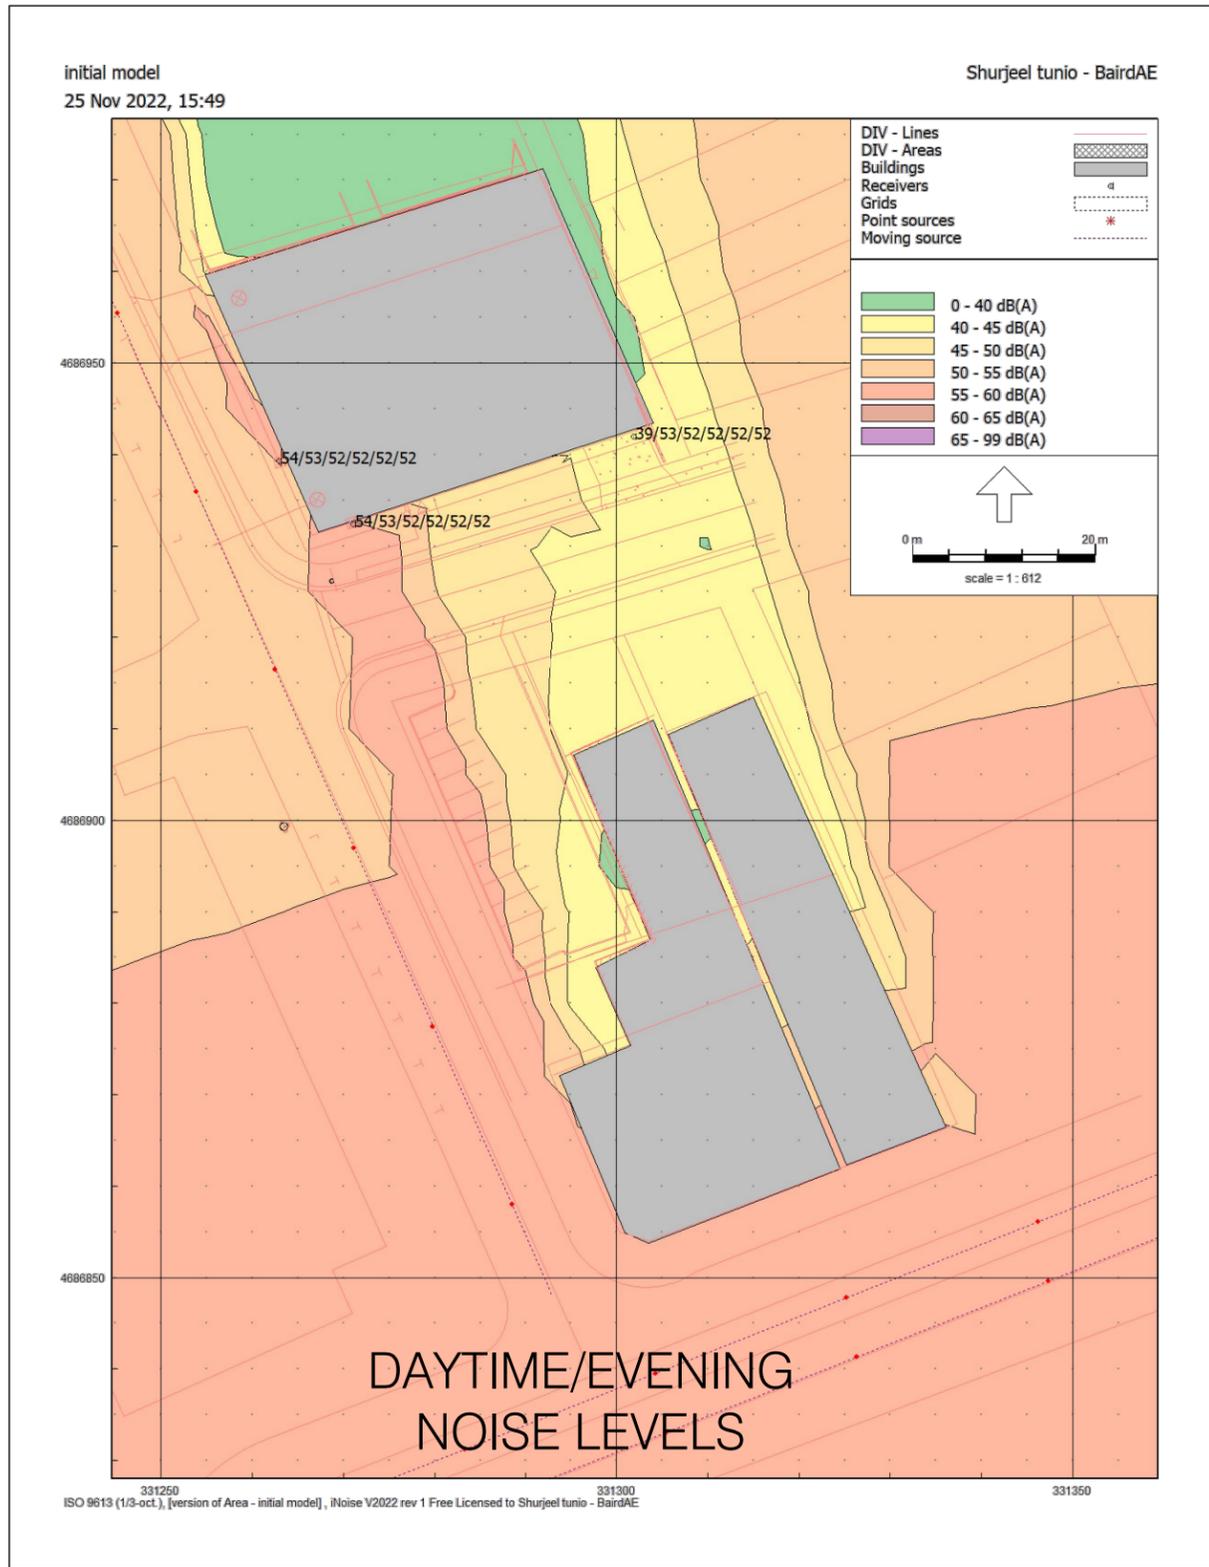

**LEGEND**

- RECEIVER LOCATION
- PROPOSED DEVELOPMENT
- NOISE SOURCES



PROJECT TITLE:  
696 CHATHAM STREET WEST  
CITY OF WINDSOR  
WINDSOR, ON

SHEET TITLE:  
FIGURE 3 - POST DEVELOPMENT NOISE LEVEL

DRAWN BY: S.T.	SCALE: NTS	DATE: NOV 22 2022
CHECK'D BY: ST.	SHEET No. : 3 OF 3	PROJECT No. : 21-170

Data Logger 2

SET 1

A

SLOW

Range 40-100

L05 57.9

L10 55.2

L50 51.2

L90 47.8

L95 47.2

Max dB 66.4

2022/11/22 03:54:20

SEL 83.6

Leq 53.3

No.s	Date	Time	dB
1	2022-11-22	03:48:54	54.7
2	2022-11-22	03:48:55	53.6
3	2022-11-22	03:48:56	51.8
4	2022-11-22	03:48:57	50.8
5	2022-11-22	03:48:58	49.7
6	2022-11-22	03:48:59	49.7
7	2022-11-22	03:49:00	51.1
8	2022-11-22	03:49:01	56.9
9	2022-11-22	03:49:02	54.4
10	2022-11-22	03:49:03	52.3
11	2022-11-22	03:49:04	51.0
12	2022-11-22	03:49:05	50.4
13	2022-11-22	03:49:06	50.7
14	2022-11-22	03:49:07	49.9
15	2022-11-22	03:49:08	51.3
16	2022-11-22	03:49:09	50.6
17	2022-11-22	03:49:10	50.2
18	2022-11-22	03:49:11	49.5
19	2022-11-22	03:49:12	49.7
20	2022-11-22	03:49:13	49.4
21	2022-11-22	03:49:14	49.7
22	2022-11-22	03:49:15	51.1
23	2022-11-22	03:49:16	50.0
24	2022-11-22	03:49:17	49.8
25	2022-11-22	03:49:18	49.8
26	2022-11-22	03:49:19	50.1
27	2022-11-22	03:49:20	49.9
28	2022-11-22	03:49:21	49.8
29	2022-11-22	03:49:22	50.7
30	2022-11-22	03:49:23	50.6
31	2022-11-22	03:49:24	50.5
32	2022-11-22	03:49:25	51.0
33	2022-11-22	03:49:26	52.3
34	2022-11-22	03:49:27	53.7
35	2022-11-22	03:49:28	53.0
36	2022-11-22	03:49:29	52.0
37	2022-11-22	03:49:30	52.1
38	2022-11-22	03:49:31	53.3
39	2022-11-22	03:49:32	54.9
40	2022-11-22	03:49:33	54.4
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42	2022-11-22	03:49:35	52.0
43	2022-11-22	03:49:36	51.3
44	2022-11-22	03:49:37	50.5
45	2022-11-22	03:49:38	49.9

46	2022-11-22	03:49:39	49.7
47	2022-11-22	03:49:40	49.6
48	2022-11-22	03:49:41	50.7
49	2022-11-22	03:49:42	50.0
50	2022-11-22	03:49:43	51.8
51	2022-11-22	03:49:44	51.2
52	2022-11-22	03:49:45	51.3
53	2022-11-22	03:49:46	51.1
54	2022-11-22	03:49:47	51.4
55	2022-11-22	03:49:48	51.9
56	2022-11-22	03:49:49	53.7
57	2022-11-22	03:49:50	52.4
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60	2022-11-22	03:49:53	52.5
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66	2022-11-22	03:49:59	55.8
67	2022-11-22	03:50:00	54.8
68	2022-11-22	03:50:01	53.5
69	2022-11-22	03:50:02	53.0
70	2022-11-22	03:50:03	52.6
71	2022-11-22	03:50:04	53.4
72	2022-11-22	03:50:05	53.4
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85	2022-11-22	03:50:18	52.4
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89	2022-11-22	03:50:22	49.7
90	2022-11-22	03:50:23	49.3
91	2022-11-22	03:50:24	49.3
92	2022-11-22	03:50:25	48.2
93	2022-11-22	03:50:26	47.5
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96	2022-11-22	03:50:29	48.2
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105	2022-11-22	03:50:38	51.2

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107	2022-11-22	03:50:40	52.2
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125	2022-11-22	03:50:58	50.4
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131	2022-11-22	03:51:04	50.6
132	2022-11-22	03:51:05	50.4
133	2022-11-22	03:51:06	51.0
134	2022-11-22	03:51:07	51.3
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214	2022-11-22	03:52:27	63.9
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222	2022-11-22	03:52:35	53.6
223	2022-11-22	03:52:36	53.0
224	2022-11-22	03:52:37	52.6
225	2022-11-22	03:52:38	52.3

226	2022-11-22	03:52:39	54.4	286	2022-11-22	03:53:39	50.2
227	2022-11-22	03:52:40	55.9	287	2022-11-22	03:53:40	50.6
228	2022-11-22	03:52:41	56.2	288	2022-11-22	03:53:41	50.7
229	2022-11-22	03:52:42	55.2	289	2022-11-22	03:53:42	51.3
230	2022-11-22	03:52:43	53.7	290	2022-11-22	03:53:43	50.9
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232	2022-11-22	03:52:45	54.9	292	2022-11-22	03:53:45	51.1
233	2022-11-22	03:52:46	55.1	293	2022-11-22	03:53:46	51.0
234	2022-11-22	03:52:47	54.4	294	2022-11-22	03:53:47	50.8
235	2022-11-22	03:52:48	53.6	295	2022-11-22	03:53:48	50.4
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241	2022-11-22	03:52:54	49.3	301	2022-11-22	03:53:54	49.4
242	2022-11-22	03:52:55	50.6	302	2022-11-22	03:53:55	49.3
243	2022-11-22	03:52:56	50.8	303	2022-11-22	03:53:56	50.1
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247	2022-11-22	03:53:00	53.8	307	2022-11-22	03:54:00	49.7
248	2022-11-22	03:53:01	54.8	308	2022-11-22	03:54:01	50.2
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254	2022-11-22	03:53:07	53.8	314	2022-11-22	03:54:07	52.7
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643	2022-11-22	03:59:36	49.3
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646	2022-11-22	03:59:39	49.1
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648	2022-11-22	03:59:41	48.6
649	2022-11-22	03:59:42	48.2
650	2022-11-22	03:59:43	47.7
651	2022-11-22	03:59:44	47.3
652	2022-11-22	03:59:45	47.1
653	2022-11-22	03:59:46	47.2
654	2022-11-22	03:59:47	47.2
655	2022-11-22	03:59:48	47.0
656	2022-11-22	03:59:49	47.2
657	2022-11-22	03:59:50	47.3
658	2022-11-22	03:59:51	47.4
659	2022-11-22	03:59:52	47.8
660	2022-11-22	03:59:53	49.2
661	2022-11-22	03:59:54	52.5
662	2022-11-22	03:59:55	58.4
663	2022-11-22	03:59:56	61.9
664	2022-11-22	03:59:57	62.0
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666	2022-11-22	03:59:59	58.6
667	2022-11-22	04:00:00	56.2
668	2022-11-22	04:00:01	54.0
669	2022-11-22	04:00:02	52.1
670	2022-11-22	04:00:03	50.7
671	2022-11-22	04:00:04	49.9
672	2022-11-22	04:00:05	48.8
673	2022-11-22	04:00:06	48.0
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675	2022-11-22	04:00:08	47.7
676	2022-11-22	04:00:09	47.8
677	2022-11-22	04:00:10	48.1
678	2022-11-22	04:00:11	50.7
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686	2022-11-22	04:00:19	52.6
687	2022-11-22	04:00:20	51.9
688	2022-11-22	04:00:21	51.9
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696	2022-11-22	04:00:29	51.6
697	2022-11-22	04:00:30	51.9
698	2022-11-22	04:00:31	51.6
699	2022-11-22	04:00:32	51.4
700	2022-11-22	04:00:33	51.4
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704	2022-11-22	04:00:37	50.8
705	2022-11-22	04:00:38	51.4

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707	2022-11-22	04:00:40	52.8	767	2022-11-22	04:01:40	50.3
708	2022-11-22	04:00:41	52.7	768	2022-11-22	04:01:41	49.9
709	2022-11-22	04:00:42	52.6	769	2022-11-22	04:01:42	49.8
710	2022-11-22	04:00:43	52.6	770	2022-11-22	04:01:43	50.3
711	2022-11-22	04:00:44	54.7	771	2022-11-22	04:01:44	51.2
712	2022-11-22	04:00:45	58.9	772	2022-11-22	04:01:45	54.6
713	2022-11-22	04:00:46	62.0	773	2022-11-22	04:01:46	58.0
714	2022-11-22	04:00:47	62.1	774	2022-11-22	04:01:47	59.7
715	2022-11-22	04:00:48	60.9	775	2022-11-22	04:01:48	58.0
716	2022-11-22	04:00:49	58.5	776	2022-11-22	04:01:49	56.0
717	2022-11-22	04:00:50	56.0	777	2022-11-22	04:01:50	53.9
718	2022-11-22	04:00:51	54.2	778	2022-11-22	04:01:51	52.7
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720	2022-11-22	04:00:53	50.9	780	2022-11-22	04:01:53	57.8
721	2022-11-22	04:00:54	49.6	781	2022-11-22	04:01:54	59.9
722	2022-11-22	04:00:55	48.8	782	2022-11-22	04:01:55	59.5
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724	2022-11-22	04:00:57	47.9	784	2022-11-22	04:01:57	56.5
725	2022-11-22	04:00:58	47.4	785	2022-11-22	04:01:58	54.6
726	2022-11-22	04:00:59	46.9	786	2022-11-22	04:01:59	53.3
727	2022-11-22	04:01:00	46.6	787	2022-11-22	04:02:00	52.4
728	2022-11-22	04:04:01	46.7	788	2022-11-22	04:02:01	51.7
729	2022-11-22	04:01:02	47.2	789	2022-11-22	04:02:02	52.5
730	2022-11-22	04:01:03	47.6	790	2022-11-22	04:02:03	52.6
731	2022-11-22	04:01:04	49.5	791	2022-11-22	04:02:04	52.5
732	2022-11-22	04:01:05	49.8	792	2022-11-22	04:02:05	52.4
733	2022-11-22	04:04:06	50.5	793	2022-11-22	04:02:06	53.2
734	2022-11-22	04:01:07	50.5	794	2022-11-22	04:02:07	52.6
735	2022-11-22	04:01:08	51.0	795	2022-11-22	04:02:08	52.1
736	2022-11-22	04:01:09	50.6	796	2022-11-22	04:02:09	51.9
737	2022-11-22	04:01:10	50.6	797	2022-11-22	04:02:10	51.5
738	2022-11-22	04:01:11	50.8	798	2022-11-22	04:02:11	51.1
739	2022-11-22	04:01:12	50.1	799	2022-11-22	04:02:12	51.4
740	2022-11-22	04:01:13	49.4	800	2022-11-22	04:02:13	51.3
741	2022-11-22	04:01:14	49.1	801	2022-11-22	04:02:14	51.2
742	2022-11-22	04:01:15	48.7	802	2022-11-22	04:02:15	51.1
743	2022-11-22	04:01:16	48.1	803	2022-11-22	04:02:16	50.8
744	2022-11-22	04:01:17	47.5	804	2022-11-22	04:02:17	50.4
745	2022-11-22	04:01:18	47.1	805	2022-11-22	04:02:18	50.6
746	2022-11-22	04:01:19	47.0	806	2022-11-22	04:02:19	49.7
747	2022-11-22	04:01:20	46.8	807	2022-11-22	04:02:20	48.9
748	2022-11-22	04:01:21	46.7	808	2022-11-22	04:02:21	48.7
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750	2022-11-22	04:01:23	47.3	810	2022-11-22	04:02:23	47.9
751	2022-11-22	04:01:24	47.5	811	2022-11-22	04:02:24	47.0
752	2022-11-22	04:01:25	47.9	812	2022-11-22	04:02:25	46.7
753	2022-11-22	04:01:26	48.4	813	2022-11-22	04:02:26	47.3
754	2022-11-22	04:01:27	48.8	814	2022-11-22	04:02:27	48.0
755	2022-11-22	04:01:28	48.8	815	2022-11-22	04:02:28	48.8
756	2022-11-22	04:01:29	49.0	816	2022-11-22	04:02:29	51.2
757	2022-11-22	04:01:30	49.9	817	2022-11-22	04:02:30	52.4
758	2022-11-22	04:01:31	49.2	818	2022-11-22	04:02:31	52.6
759	2022-11-22	04:01:32	49.5	819	2022-11-22	04:02:32	52.8
760	2022-11-22	04:01:33	50.2	820	2022-11-22	04:02:33	54.5
761	2022-11-22	04:01:34	51.0	821	2022-11-22	04:02:34	54.6
762	2022-11-22	04:01:35	52.0	822	2022-11-22	04:02:35	54.4
763	2022-11-22	04:01:36	50.5	823	2022-11-22	04:02:36	53.9
764	2022-11-22	04:01:37	50.2	824	2022-11-22	04:02:37	53.5
765	2022-11-22	04:01:38	50.6	825	2022-11-22	04:02:38	53.5

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828	2022-11-22	04:02:41	52.9	888	2022-11-22	04:03:41	49.8
829	2022-11-22	04:02:42	52.2	889	2022-11-22	04:03:42	49.1
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831	2022-11-22	04:02:44	51.4	891	2022-11-22	04:03:44	49.0
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836	2022-11-22	04:02:49	50.7	896	2022-11-22	04:03:49	53.1
837	2022-11-22	04:02:50	49.9	897	2022-11-22	04:03:50	53.9
838	2022-11-22	04:02:51	50.0	898	2022-11-22	04:03:51	54.9
839	2022-11-22	04:02:52	49.6	899	2022-11-22	04:03:52	55.6
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866	2022-11-22	04:03:19	50.3	926	2022-11-22	04:04:19	54.3
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876	2022-11-22	04:03:29	51.4	936	2022-11-22	04:04:29	48.2
877	2022-11-22	04:03:30	51.3	937	2022-11-22	04:04:30	48.5
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882	2022-11-22	04:03:35	48.9	942	2022-11-22	04:04:35	47.0
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885	2022-11-22	04:03:38	48.0	945	2022-11-22	04:04:38	47.4

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951	2022-11-22	04:04:44	48.7
952	2022-11-22	04:04:45	48.5
953	2022-11-22	04:04:46	49.0
954	2022-11-22	04:04:47	49.6
955	2022-11-22	04:04:48	49.4
956	2022-11-22	04:04:49	48.1
957	2022-11-22	04:04:50	47.7
958	2022-11-22	04:04:51	47.8
959	2022-11-22	04:04:52	47.9
960	2022-11-22	04:04:53	49.0
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962	2022-11-22	04:04:55	50.4
963	2022-11-22	04:04:56	50.9
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971	2022-11-22	04:05:04	53.9
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981	2022-11-22	04:05:14	51.5
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986	2022-11-22	04:05:19	50.1
987	2022-11-22	04:05:20	50.0
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989	2022-11-22	04:05:22	50.8
990	2022-11-22	04:05:23	51.0
991	2022-11-22	04:05:24	50.9
992	2022-11-22	04:05:25	51.2
993	2022-11-22	04:05:26	51.9
994	2022-11-22	04:05:27	52.1
995	2022-11-22	04:05:28	52.4
996	2022-11-22	04:05:29	51.9
997	2022-11-22	04:05:30	51.5
998	2022-11-22	04:05:31	52.2
999	2022-11-22	04:05:32	52.4
1000	2022-11-22	04:05:33	51.9
1001	2022-11-22	04:05:34	52.9
1002	2022-11-22	04:05:35	51.8
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1004	2022-11-22	04:05:37	50.4
1005	2022-11-22	04:05:38	49.9

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1008	2022-11-22	04:05:41	50.8
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1011	2022-11-22	04:05:44	51.1
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1014	2022-11-22	04:05:47	53.2
1015	2022-11-22	04:05:48	53.5
1016	2022-11-22	04:05:49	52.8
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1018	2022-11-22	04:05:51	52.9
1019	2022-11-22	04:05:52	52.9
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1021	2022-11-22	04:05:54	51.9
1022	2022-11-22	04:05:55	50.5
1023	2022-11-22	04:05:56	50.2
1024	2022-11-22	04:05:57	49.9
1025	2022-11-22	04:05:58	50.0
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1027	2022-11-22	04:06:00	48.4
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1033	2022-11-22	04:06:06	51.1
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1035	2022-11-22	04:06:08	53.0
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1037	2022-11-22	04:06:10	53.7
1038	2022-11-22	04:06:11	56.1
1039	2022-11-22	04:06:12	58.0
1040	2022-11-22	04:06:13	59.5
1041	2022-11-22	04:06:14	58.4
1042	2022-11-22	04:06:15	56.9
1043	2022-11-22	04:06:16	55.2
1044	2022-11-22	04:06:17	53.5
1045	2022-11-22	04:06:18	52.4
1046	2022-11-22	04:06:19	51.7
1047	2022-11-22	04:06:20	51.4
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1050	2022-11-22	04:06:23	51.4
1051	2022-11-22	04:06:24	51.6
1052	2022-11-22	04:06:25	52.0
1053	2022-11-22	04:06:26	51.8
1054	2022-11-22	04:06:27	52.6
1055	2022-11-22	04:06:28	53.0
1056	2022-11-22	04:06:29	53.2
1057	2022-11-22	04:06:30	53.2
1058	2022-11-22	04:06:31	53.4
1059	2022-11-22	04:06:32	53.2
1060	2022-11-22	04:06:33	52.9
1061	2022-11-22	04:06:34	53.2
1062	2022-11-22	04:06:35	52.0
1063	2022-11-22	04:06:36	51.7
1064	2022-11-22	04:06:37	51.6
1065	2022-11-22	04:06:38	50.7

1066	2022-11-22	04:06:39	50.5
1067	2022-11-22	04:06:40	50.1
1068	2022-11-22	04:06:41	49.9
1069	2022-11-22	04:06:42	50.3
1070	2022-11-22	04:06:43	49.8
1071	2022-11-22	04:06:44	48.9
1072	2022-11-22	04:06:45	49.1
1073	2022-11-22	04:06:46	50.2
1074	2022-11-22	04:06:47	51.4
1075	2022-11-22	04:06:48	51.7
1076	2022-11-22	04:06:49	52.7
1077	2022-11-22	04:06:50	51.7
1078	2022-11-22	04:06:51	49.5*
1079	2022-11-22	04:06:52	48.2*
1080	2022-11-22	04:06:53	47.7*
1081	2022-11-22	04:06:54	47.4*
1082	2022-11-22	04:06:55	47.0*
1083	2022-11-22	04:06:56	47.0*
1084	2022-11-22	04:06:57	47.3
1085	2022-11-22	04:06:58	47.3

Data Logger 2

SET 1  
A  
SLOW  
Range 40-100  
L05 61.7  
L10 58.9  
L50 53.0  
L90 49.7  
L95 48.9  
Max dB 73.7  
2022/11/22 01:21:34  
SEL 87.3  
Leq 56.4

No.s	Date Time	dB
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2	2022-11-22 01:07:24	52.7
3	2022-11-22 01:07:25	55.4
4	2022-11-22 01:07:26	54.1
5	2022-11-22 01:07:27	54.7
6	2022-11-22 01:07:28	56.2
7	2022-11-22 01:07:29	55.3
8	2022-11-22 01:07:30	54.6
9	2022-11-22 01:07:31	53.7
10	2022-11-22 01:07:32	53.2
11	2022-11-22 01:07:33	52.7
12	2022-11-22 01:07:34	53.0
13	2022-11-22 01:07:35	52.7
14	2022-11-22 01:07:36	52.5
15	2022-11-22 01:07:37	51.9
16	2022-11-22 01:07:38	51.4
17	2022-11-22 01:07:39	51.5
18	2022-11-22 01:07:40	51.8
19	2022-11-22 01:07:41	51.9
20	2022-11-22 01:07:42	52.8
21	2022-11-22 01:07:43	52.9
22	2022-11-22 01:07:44	52.9
23	2022-11-22 01:07:45	54.6
24	2022-11-22 01:07:46	59.6
25	2022-11-22 01:07:47	64.1
26	2022-11-22 01:07:48	66.5
27	2022-11-22 01:07:49	65.0
28	2022-11-22 01:07:50	62.1
29	2022-11-22 01:07:51	59.4
30	2022-11-22 01:07:52	57.1
31	2022-11-22 01:07:53	55.3
32	2022-11-22 01:07:54	54.1
33	2022-11-22 01:07:55	52.7
34	2022-11-22 01:07:56	52.8
35	2022-11-22 01:07:57	53.0
36	2022-11-22 01:07:58	52.7
37	2022-11-22 01:07:59	52.1
38	2022-11-22 01:08:00	52.2
39	2022-11-22 01:08:01	52.0
40	2022-11-22 01:08:02	51.5
41	2022-11-22 01:08:03	52.4
42	2022-11-22 01:08:04	52.4
43	2022-11-22 01:08:05	52.0
44	2022-11-22 01:08:06	52.7
45	2022-11-22 01:08:07	52.4

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47	2022-11-22 01:08:09	52.3
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51	2022-11-22 01:08:13	53.9
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67	2022-11-22 01:08:29	52.3
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69	2022-11-22 01:08:31	52.7
70	2022-11-22 01:08:32	52.3
71	2022-11-22 01:08:33	52.2
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73	2022-11-22 01:08:35	52.3
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91	2022-11-22 01:08:53	64.1
92	2022-11-22 01:08:54	64.0
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94	2022-11-22 01:08:56	59.2
95	2022-11-22 01:08:57	56.3
96	2022-11-22 01:08:58	54.1
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103	2022-11-22 01:09:05	66.1
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105	2022-11-22 01:09:07	60.2

106	2022-11-22 01:09:08	57.2
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152	2022-11-22 01:09:54	60.1
153	2022-11-22 01:09:55	57.3
154	2022-11-22 01:09:56	54.4
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156	2022-11-22 01:09:58	50.9
157	2022-11-22 01:09:59	53.2
158	2022-11-22 01:10:00	53.6
159	2022-11-22 01:10:01	55.8
160	2022-11-22 01:10:02	56.0
161	2022-11-22 01:10:03	55.1
162	2022-11-22 01:10:04	54.6
163	2022-11-22 01:10:05	54.0
164	2022-11-22 01:10:06	53.5
165	2022-11-22 01:10:07	53.4

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169	2022-11-22 01:10:11	54.4
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188	2022-11-22 01:10:30	54.4
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191	2022-11-22 01:10:33	53.6
192	2022-11-22 01:10:34	52.7
193	2022-11-22 01:10:35	51.6
194	2022-11-22 01:10:36	51.3
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201	2022-11-22 01:10:43	50.9
202	2022-11-22 01:10:44	50.9
203	2022-11-22 01:10:45	51.1
204	2022-11-22 01:10:46	51.4
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207	2022-11-22 01:10:49	51.8
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209	2022-11-22 01:10:51	52.5
210	2022-11-22 01:10:52	53.7
211	2022-11-22 01:10:53	53.1
212	2022-11-22 01:10:54	52.7
213	2022-11-22 01:10:55	52.5
214	2022-11-22 01:10:56	51.8
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216	2022-11-22 01:10:58	51.5
217	2022-11-22 01:10:59	50.9
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219	2022-11-22 01:11:01	50.0
220	2022-11-22 01:11:02	49.6
221	2022-11-22 01:11:03	49.1
222	2022-11-22 01:11:04	48.7
223	2022-11-22 01:11:05	48.6
224	2022-11-22 01:11:06	49.2
225	2022-11-22 01:11:07	49.4

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237	2022-11-22	01:11:19	50.4
238	2022-11-22	01:11:20	51.1
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241	2022-11-22	01:11:23	55.2
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247	2022-11-22	01:11:29	53.0
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276	2022-11-22	01:11:58	51.8
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404	2022-11-22	01:14:06	53.4
405	2022-11-22	01:14:07	53.4

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307	2022-11-22	01:12:29	50.3
308	2022-11-22	01:12:30	50.0
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310	2022-11-22	01:12:32	50.3
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312	2022-11-22	01:12:34	50.4
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317	2022-11-22	01:12:39	47.7
318	2022-11-22	01:12:40	47.9
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320	2022-11-22	01:12:42	49.0
321	2022-11-22	01:12:43	56.2
322	2022-11-22	01:12:44	53.5
323	2022-11-22	01:12:45	52.0
324	2022-11-22	01:12:46	51.0
325	2022-11-22	01:12:47	51.6
326	2022-11-22	01:12:48	51.3
327	2022-11-22	01:12:49	51.8
328	2022-11-22	01:12:50	51.5
329	2022-11-22	01:12:51	51.8
330	2022-11-22	01:12:52	52.7
331	2022-11-22	01:12:53	55.1
332	2022-11-22	01:12:54	54.3
333	2022-11-22	01:12:55	53.7
334	2022-11-22	01:12:56	53.6
335	2022-11-22	01:12:57	53.6
336	2022-11-22	01:12:58	53.8
337	2022-11-22	01:12:59	57.1
338	2022-11-22	01:13:00	58.3
339	2022-11-22	01:13:01	57.0
340	2022-11-22	01:13:02	55.1
341	2022-11-22	01:13:03	54.2
342	2022-11-22	01:13:04	54.1
343	2022-11-22	01:13:05	54.0
344	2022-11-22	01:13:06	55.2
345	2022-11-22	01:13:07	54.8

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407	2022-11-22	01:14:09	53.4
408	2022-11-22	01:14:10	53.5
409	2022-11-22	01:14:11	53.5
410	2022-11-22	01:14:12	55.4
411	2022-11-22	01:14:13	58.3
412	2022-11-22	01:14:14	56.4
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414	2022-11-22	01:14:16	54.3
415	2022-11-22	01:14:17	54.1
416	2022-11-22	01:14:18	58.0
417	2022-11-22	01:14:19	59.6
418	2022-11-22	01:14:20	57.1
419	2022-11-22	01:14:21	55.1
420	2022-11-22	01:14:22	53.5
421	2022-11-22	01:14:23	55.1
422	2022-11-22	01:14:24	58.1
423	2022-11-22	01:14:25	57.7
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425	2022-11-22	01:14:27	61.8
426	2022-11-22	01:14:28	58.3
427	2022-11-22	01:14:29	55.1
428	2022-11-22	01:14:30	52.7
429	2022-11-22	01:14:31	51.0
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432	2022-11-22	01:14:34	50.7
433	2022-11-22	01:14:35	53.2
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462	2022-11-22	01:15:04	50.6
463	2022-11-22	01:15:05	51.5
464	2022-11-22	01:15:06	50.8
465	2022-11-22	01:15:07	51.1

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468	2022-11-22	01:15:10	51.8	528	2022-11-22	01:16:10	51.0
469	2022-11-22	01:15:11	52.7	529	2022-11-22	01:16:11	50.5
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477	2022-11-22	01:15:19	52.3	537	2022-11-22	01:16:19	51.8
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494	2022-11-22	01:15:36	64.0	554	2022-11-22	01:16:36	55.8
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496	2022-11-22	01:15:38	58.3	556	2022-11-22	01:16:38	54.2
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509	2022-11-22	01:15:51	55.6	569	2022-11-22	01:16:51	54.6
510	2022-11-22	01:15:52	54.0	570	2022-11-22	01:16:52	54.1
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512	2022-11-22	01:15:54	54.0	572	2022-11-22	01:16:54	53.7
513	2022-11-22	01:15:55	54.1	573	2022-11-22	01:16:55	53.7
514	2022-11-22	01:15:56	53.5	574	2022-11-22	01:16:56	53.6
515	2022-11-22	01:15:57	53.6	575	2022-11-22	01:16:57	52.7
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521	2022-11-22	01:16:03	65.4	581	2022-11-22	01:17:03	50.5
522	2022-11-22	01:16:04	65.6	582	2022-11-22	01:17:04	50.9
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524	2022-11-22	01:16:06	59.8	584	2022-11-22	01:17:06	52.3
525	2022-11-22	01:16:07	56.5	585	2022-11-22	01:17:07	51.7

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597	2022-11-22	01:17:19	49.9	657	2022-11-22	01:18:19	53.5
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599	2022-11-22	01:17:21	50.2	659	2022-11-22	01:18:21	53.2
600	2022-11-22	01:17:22	50.5	660	2022-11-22	01:18:22	53.1
601	2022-11-22	01:17:23	52.1	661	2022-11-22	01:18:23	52.8
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611	2022-11-22	01:17:33	56.3	671	2022-11-22	01:18:33	50.1
612	2022-11-22	01:17:34	57.7	672	2022-11-22	01:18:34	49.7
613	2022-11-22	01:17:35	55.2	673	2022-11-22	01:18:35	49.4
614	2022-11-22	01:17:36	53.2	674	2022-11-22	01:18:36	49.8
615	2022-11-22	01:17:37	51.9	675	2022-11-22	01:18:37	51.2
616	2022-11-22	01:17:38	51.8	676	2022-11-22	01:18:38	50.4
617	2022-11-22	01:17:39	55.5	677	2022-11-22	01:18:39	50.2
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619	2022-11-22	01:17:41	52.7	679	2022-11-22	01:18:41	50.2
620	2022-11-22	01:17:42	52.4	680	2022-11-22	01:18:42	51.0
621	2022-11-22	01:17:43	51.7	681	2022-11-22	01:18:43	51.0
622	2022-11-22	01:17:44	52.1	682	2022-11-22	01:18:44	50.4
623	2022-11-22	01:17:45	51.5	683	2022-11-22	01:18:45	50.1
624	2022-11-22	01:17:46	51.8	684	2022-11-22	01:18:46	49.8
625	2022-11-22	01:17:47	52.2	685	2022-11-22	01:18:47	49.7
626	2022-11-22	01:17:48	54.5	686	2022-11-22	01:18:48	49.8
627	2022-11-22	01:17:49	57.6	687	2022-11-22	01:18:49	49.6
628	2022-11-22	01:17:50	57.4	688	2022-11-22	01:18:50	49.8
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632	2022-11-22	01:17:54	62.2	692	2022-11-22	01:18:54	49.7
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644	2022-11-22	01:18:06	53.0	704	2022-11-22	01:19:06	55.3
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712	2022-11-22	01:19:14	57.5
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714	2022-11-22	01:19:16	53.9
715	2022-11-22	01:19:17	53.6
716	2022-11-22	01:19:18	53.4
717	2022-11-22	01:19:19	53.8
718	2022-11-22	01:19:20	54.2
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722	2022-11-22	01:19:24	54.0
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725	2022-11-22	01:19:27	53.8
726	2022-11-22	01:19:28	53.5
727	2022-11-22	01:19:29	53.7
728	2022-11-22	01:19:30	53.0
729	2022-11-22	01:19:31	52.4
730	2022-11-22	01:19:32	52.7
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732	2022-11-22	01:19:34	51.7
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735	2022-11-22	01:19:37	50.3
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747	2022-11-22	01:19:49	51.2
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749	2022-11-22	01:19:51	50.8
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752	2022-11-22	01:19:54	50.8
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764	2022-11-22	01:20:06	48.9
765	2022-11-22	01:20:07	48.8

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768	2022-11-22	01:20:10	49.4
769	2022-11-22	01:20:11	49.5
770	2022-11-22	01:20:12	49.0
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772	2022-11-22	01:20:14	49.0
773	2022-11-22	01:20:15	49.3
774	2022-11-22	01:20:16	49.7
775	2022-11-22	01:20:17	50.2
776	2022-11-22	01:20:18	50.8
777	2022-11-22	01:20:19	50.9
778	2022-11-22	01:20:20	51.3
779	2022-11-22	01:20:21	51.0
780	2022-11-22	01:20:22	51.6
781	2022-11-22	01:20:23	51.9
782	2022-11-22	01:20:24	51.6
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784	2022-11-22	01:20:26	51.3
785	2022-11-22	01:20:27	51.1
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788	2022-11-22	01:20:30	51.8
789	2022-11-22	01:20:31	52.3
790	2022-11-22	01:20:32	53.2
791	2022-11-22	01:20:33	53.4
792	2022-11-22	01:20:34	53.8
793	2022-11-22	01:20:35	53.6
794	2022-11-22	01:20:36	53.5
795	2022-11-22	01:20:37	53.7
796	2022-11-22	01:20:38	54.0
797	2022-11-22	01:20:39	54.8
798	2022-11-22	01:20:40	55.9
799	2022-11-22	01:20:41	56.2
800	2022-11-22	01:20:42	55.2
801	2022-11-22	01:20:43	54.4
802	2022-11-22	01:20:44	54.2
803	2022-11-22	01:20:45	53.6
804	2022-11-22	01:20:46	52.9
805	2022-11-22	01:20:47	53.9
806	2022-11-22	01:20:48	54.0
807	2022-11-22	01:20:49	53.8
808	2022-11-22	01:20:50	53.1
809	2022-11-22	01:20:51	53.5
810	2022-11-22	01:20:52	52.4
811	2022-11-22	01:20:53	51.9
812	2022-11-22	01:20:54	51.5
813	2022-11-22	01:20:55	51.2
814	2022-11-22	01:20:56	51.1
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816	2022-11-22	01:20:58	53.5
817	2022-11-22	01:20:59	54.5
818	2022-11-22	01:21:00	53.6
819	2022-11-22	01:21:01	53.6
820	2022-11-22	01:21:02	53.1
821	2022-11-22	01:21:03	52.5
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823	2022-11-22	01:21:05	53.8
824	2022-11-22	01:21:06	53.6
825	2022-11-22	01:21:07	54.4

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827	2022-11-22	01:21:09	55.4
828	2022-11-22	01:21:10	58.0
829	2022-11-22	01:21:11	58.3
830	2022-11-22	01:21:12	55.7
831	2022-11-22	01:21:13	56.8
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833	2022-11-22	01:21:15	58.7
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836	2022-11-22	01:21:18	53.9
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844	2022-11-22	01:21:26	55.6
845	2022-11-22	01:21:27	55.9
846	2022-11-22	01:21:28	57.0
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848	2022-11-22	01:21:30	63.2
849	2022-11-22	01:21:31	66.1
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852	2022-11-22	01:21:34	72.3
853	2022-11-22	01:21:35	69.7
854	2022-11-22	01:21:36	67.0
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856	2022-11-22	01:21:38	61.8
857	2022-11-22	01:21:39	58.4
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861	2022-11-22	01:21:43	53.2
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863	2022-11-22	01:21:45	53.0
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865	2022-11-22	01:21:47	54.4
866	2022-11-22	01:21:48	54.0
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868	2022-11-22	01:21:50	55.2
869	2022-11-22	01:21:51	55.5
870	2022-11-22	01:21:52	56.5
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873	2022-11-22	01:21:55	63.3
874	2022-11-22	01:21:56	64.3
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876	2022-11-22	01:21:58	62.3
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891	2022-11-22	01:22:13	52.2
892	2022-11-22	01:22:14	52.0
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894	2022-11-22	01:22:16	52.1
895	2022-11-22	01:22:17	52.0
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916	2022-11-22	01:22:38	50.2
917	2022-11-22	01:22:39	50.0
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919	2022-11-22	01:22:41	52.4
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927	2022-11-22	01:22:49	52.2
928	2022-11-22	01:22:50	51.4
929	2022-11-22	01:22:51	50.7
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931	2022-11-22	01:22:53	51.6
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933	2022-11-22	01:22:55	50.3
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935	2022-11-22	01:22:57	51.6
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937	2022-11-22	01:22:59	53.0
938	2022-11-22	01:23:00	51.6
939	2022-11-22	01:23:01	51.4
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941	2022-11-22	01:23:03	52.4
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943	2022-11-22	01:23:05	53.5
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945	2022-11-22	01:23:07	54.6

946	2022-11-22	01:23:08	54.1	1006	2022-11-22	01:24:08	50.4
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964	2022-11-22	01:23:26	54.2	1024	2022-11-22	01:24:26	50.1
965	2022-11-22	01:23:27	55.2	1025	2022-11-22	01:24:27	50.0
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984	2022-11-22	01:23:46	49.8	1044	2022-11-22	01:24:46	51.5
985	2022-11-22	01:23:47	49.2	1045	2022-11-22	01:24:47	50.5
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990	2022-11-22	01:23:52	48.2	1050	2022-11-22	01:24:52	48.0
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998	2022-11-22	01:24:00	50.1	1058	2022-11-22	01:25:00	48.8
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1002	2022-11-22	01:24:04	50.0	1062	2022-11-22	01:25:04	48.6
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1004	2022-11-22	01:24:06	49.7	1064	2022-11-22	01:25:06	48.8
1005	2022-11-22	01:24:07	50.3	1065	2022-11-22	01:25:07	48.7

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1186	2022-11-22	01:27:08	61.7
1187	2022-11-22	01:27:09	65.0
1188	2022-11-22	01:27:10	64.4
1189	2022-11-22	01:27:11	62.4
1190	2022-11-22	01:27:12	59.6
1191	2022-11-22	01:27:13	56.5
1192	2022-11-22	01:27:14	55.0
1193	2022-11-22	01:27:15	54.5
1194	2022-11-22	01:27:16	53.7
1195	2022-11-22	01:27:17	56.6
1196	2022-11-22	01:27:18	55.6
1197	2022-11-22	01:27:19	56.7
1198	2022-11-22	01:27:20	54.3
1199	2022-11-22	01:27:21	53.8
1200	2022-11-22	01:27:22	52.4
1201	2022-11-22	01:27:23	52.2
1202	2022-11-22	01:27:24	51.3
1203	2022-11-22	01:27:25	50.3
1204	2022-11-22	01:27:26	49.8
1205	2022-11-22	01:27:27	49.8
1206	2022-11-22	01:27:28	51.8
1207	2022-11-22	01:27:29	51.9
1208	2022-11-22	01:27:30	53.0
1209	2022-11-22	01:27:31	52.5
1210	2022-11-22	01:27:32	52.5
1211	2022-11-22	01:27:33	52.9
1212	2022-11-22	01:27:34	52.2
1213	2022-11-22	01:27:35	51.7
1214	2022-11-22	01:27:36	54.4
1215	2022-11-22	01:27:37	52.9
1216	2022-11-22	01:27:38	52.8
1217	2022-11-22	01:27:39	52.5
1218	2022-11-22	01:27:40	51.3
1219	2022-11-22	01:27:41	51.7
1220	2022-11-22	01:27:42	50.8
1221	2022-11-22	01:27:43	52.6
1222	2022-11-22	01:27:44	53.0
1223	2022-11-22	01:27:45	54.7
1224	2022-11-22	01:27:46	56.9
1225	2022-11-22	01:27:47	58.6
1226	2022-11-22	01:27:48	61.1
1227	2022-11-22	01:27:49	64.2
1228	2022-11-22	01:27:50	65.1
1229	2022-11-22	01:27:51	64.6
1230	2022-11-22	01:27:52	62.9
1231	2022-11-22	01:27:53	61.2
1232	2022-11-22	01:27:54	59.6
1233	2022-11-22	01:27:55	57.9
1234	2022-11-22	01:27:56	56.4
1235	2022-11-22	01:27:57	55.8
1236	2022-11-22	01:27:58	60.3
1237	2022-11-22	01:27:59	65.1
1238	2022-11-22	01:28:00	66.4
1239	2022-11-22	01:28:01	64.7
1240	2022-11-22	01:28:02	61.8
1241	2022-11-22	01:28:03	59.7
1242	2022-11-22	01:28:04	58.0
1243	2022-11-22	01:28:05	55.5
1244	2022-11-22	01:28:06	54.1
1245	2022-11-22	01:28:07	54.5

1246	2022-11-22	01:28:08	54.6
1247	2022-11-22	01:28:09	53.9
1248	2022-11-22	01:28:10	54.0
1249	2022-11-22	01:28:11	53.5
1250	2022-11-22	01:28:12	53.8
1251	2022-11-22	01:28:13	53.7
1252	2022-11-22	01:28:14	53.7
1253	2022-11-22	01:28:15	53.4
1254	2022-11-22	01:28:16	56.0
1255	2022-11-22	01:28:17	55.0
1256	2022-11-22	01:28:18	53.2
1257	2022-11-22	01:28:19	52.3*
1258	2022-11-22	01:28:20	51.6*
1259	2022-11-22	01:28:21	51.7*
1260	2022-11-22	01:28:22	51.4
1261	2022-11-22	01:28:23	52.1

## Appendix C

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### PICTURES


# VIBRATION RESULTS



# NOISE METER MONITORING




Receiver Location 1

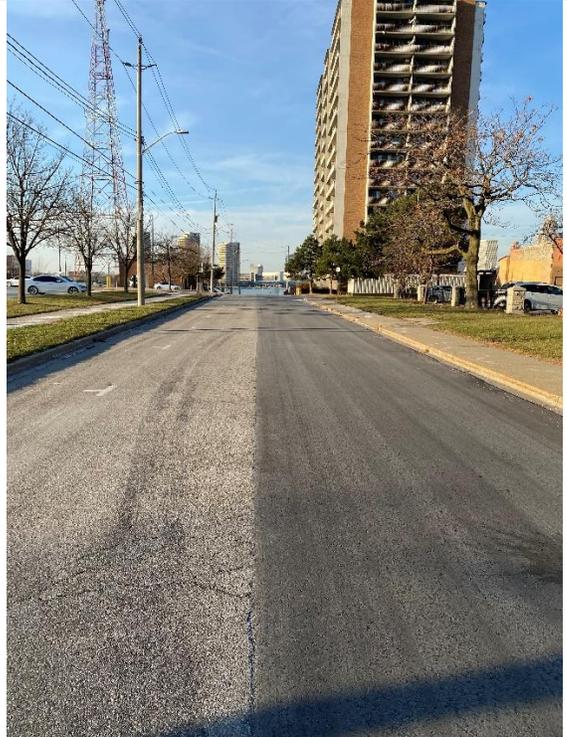

Looking North on Caron Ave



Looking West on Chatham Street

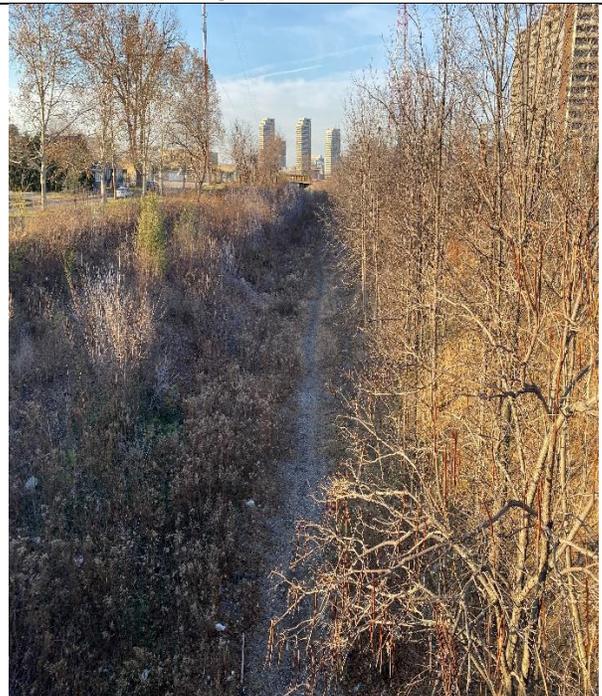


Looking North from University Avenue



Looking South from University Avenue

### FRONT VIEW OF RAIL SECTION

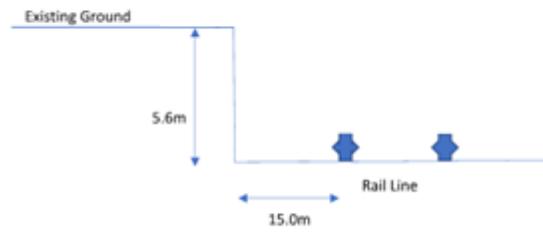

## Appendix D

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### SOUND TRANSMISSION CLASS

## 696 Chatham Street Development Building Component Review

<b>South Façade</b>					
<b>Receiver 1</b>	<b>BR/LR</b>	<b>COMPONENT</b>	<b>F AREA</b>	<b>W AREA</b>	<b>STC</b>
Floor 4 -10	Bed	Window	8.7	3.3	36
Floor 10-16	Bed	Window	8.7	3.3	35
Floor 4 -10	Living	Window	11.7	3.3	29
Floor 10-16	Living	Window	11.7	3.3	28
Floor 4-16	Living	Door	11.7	2.3	30

<b>East Façade</b>					
<b>Receiver 2</b>	<b>BR/LR</b>	<b>COMPONENT</b>	<b>F AREA</b>	<b>W AREA</b>	<b>STC</b>
Floor 4 -10	Bed	Window	8.7	3.3	35
Floor 10-16	Bed	Window	8.7	3.3	34
Floor 4 -10	Living	Window	11.7	3.3	27
Floor 10-16	Living	Window	11.7	3.3	27
Floor 4-16	Living	Door	11.7	2.3	29

<b>West Façade</b>					
<b>Receiver 3</b>	<b>BR/LR</b>	<b>COMPONENT</b>	<b>F AREA</b>	<b>W AREA</b>	<b>STC</b>
Floor 4 -10	Bed	Window	8.7	3.3	36
Floor 10-16	Bed	Window	8.7	3.3	34
Floor 4 -10	Living	Window	11.7	3.3	29
Floor 10-16	Living	Window	11.7	3.3	27
Floor 4-16	Living	Door	11.7	2.3	30

\*NOTE: STC VALUES ARE BASED OFF A SOUND LEVEL OF RECEIVER LOCATIONS

### CHATHAM DOOR WINDOWS COMPONENT

Receiver 1	BR/LR	dB(A)	STC	Noise Source	Indoor Quarters	Reflections	oor Sound Le	Sound Angle of Incidence	C1 from Table 7.7	Sum	Component	Floor Area	Component Area	Room Absorption Category	# of Components	Transmit %	C2 from Table. 7.8	Noise Spectrum Type	% Floor Area	C3 from Table 7.9	Component Category	:4 from Table 7.10
Floor 4 -10	Bed	54	36	Rail	Sleeping	3	35	60 to 90 degrees	3	25	Window	8.7	3.3	Hard	2	50	3	F - Diesel Railway Lr	37.93	-2	d. Sealed thick win	10
Floor 10-16	Bed	53	35	Rail	Sleeping	3	35	60 to 90 degrees	3	24	Window	8.7	3.3	Hard	2	50	3	F - Diesel Railway Lr	37.93	-2	d. Sealed thick win	10
Floor 4 -10	Living	51	29	Rail	Living	3	40	60 to 90 degrees	3	17	Window	11.7	3.3	Hard	3	33.33333333	5	F - Diesel Railway Lr	28.21	-3	d. Sealed thick win	10
Floor 10-16	Living	50	28	Rail	Living	3	40	60 to 90 degrees	3	16	Window	11.7	3.3	Hard	3	33.33333333	5	F - Diesel Railway Lr	28.21	-3	d. Sealed thick win	10
Floor 4-16	Living	54	30	Rail	Living	3	40	60 to 90 degrees	3	20	Door	11.7	2.3	Hard	3	33.33333333	5	F - Diesel Railway Lr	19.66	-5	d. Sealed thick win	10
				Road	Sleeping			0 to 90 degrees			Window			Very Absorptive				F - Diesel Railway Lr			c. Sealed thin wind	
<b>Receiver 2</b>	<b>BR/LR</b>	<b>dB(A)</b>	<b>STC</b>	<b>Noise Source</b>	<b>Indoor Quarters</b>	<b>Reflections</b>	<b>oor Sound Le</b>	<b>Sound Angle of Incidence</b>	<b>C1 from Table 7.7</b>	<b>Sum</b>	<b>Component</b>	<b>Floor Area</b>	<b>Component Area</b>	<b>Room Absorption Category</b>	<b># of Components</b>	<b>Transmit %</b>	<b>C2 from Table. 7.8</b>	<b>Noise Spectrum Type</b>	<b>% Floor Area</b>	<b>C3 from Table 7.9</b>	<b>Component Category</b>	<b>:4 from Table 7.10</b>
Floor 4 -10	Bed	53	35	Rail	Sleeping	3	35	60 to 90 degrees	3	24	Window	8.7	3.3	Hard	2	50	3	F - Diesel Railway Lr	37.93	-2	d. Sealed thick win	10
Floor 10-16	Bed	52	34	Rail	Sleeping	3	35	60 to 90 degrees	3	23	Window	8.7	3.3	Hard	2	50	3	F - Diesel Railway Lr	37.93	-2	d. Sealed thick win	10
Floor 4 -10	Living	49	27	Rail	Living	3	40	60 to 90 degrees	3	15	Window	11.7	3.3	Hard	3	33.33333333	5	F - Diesel Railway Lr	28.21	-3	d. Sealed thick win	10
Floor 10-16	Living	49	27	Rail	Living	3	40	60 to 90 degrees	3	15	Window	11.7	3.3	Hard	3	33.33333333	5	F - Diesel Railway Lr	28.21	-3	d. Sealed thick win	10
Floor 4-16	Living	53	29	Rail	Living	3	40	60 to 90 degrees	3	19	Door	11.7	2.3	Hard	3	33.33333333	5	F - Diesel Railway Lr	19.66	-5	d. Sealed thick win	10
				Road	Sleeping			0 to 90 degrees			Door			Very Absorptive				F - Diesel Railway Lr			c. Sealed thin wind	
<b>Receiver 3</b>	<b>BR/LR</b>	<b>dB(A)</b>	<b>STC</b>	<b>Noise Source</b>	<b>Indoor Quarters</b>	<b>Reflections</b>	<b>oor Sound Le</b>	<b>Sound Angle of Incidence</b>	<b>C1 from Table 7.7</b>	<b>Sum</b>	<b>Component</b>	<b>Floor Area</b>	<b>Component Area</b>	<b>Room Absorption Category</b>	<b># of Components</b>	<b>Transmit %</b>	<b>C2 from Table. 7.8</b>	<b>Noise Spectrum Type</b>	<b>% Floor Area</b>	<b>C3 from Table 7.9</b>	<b>Component Category</b>	<b>:4 from Table 7.10</b>
Floor 4 -10	Bed	54	36	Rail	Sleeping	3	35	60 to 90 degrees	3	25	Window	8.7	3.3	Hard	2	50	3	F - Diesel Railway Lr	37.93	-2	d. Sealed thick win	10
Floor 10-16	Bed	52	34	Rail	Sleeping	3	35	60 to 90 degrees	3	23	Window	8.7	3.3	Hard	2	50	3	F - Diesel Railway Lr	37.93	-2	d. Sealed thick win	10
Floor 4 -10	Living	51	29	Rail	Living	3	40	60 to 90 degrees	3	17	Window	11.7	3.3	Hard	3	33.33333333	5	F - Diesel Railway Lr	28.21	-3	d. Sealed thick win	10
Floor 10-16	Living	49	27	Rail	Living	3	40	60 to 90 degrees	3	15	Window	11.7	3.3	Hard	3	33.33333333	5	F - Diesel Railway Lr	28.21	-3	d. Sealed thick win	10
Floor 4-16	Living	54	30	Rail	Living	3	40	60 to 90 degrees	3	20	Window	11.7	2.3	Hard	3	33.33333333	5	F - Diesel Railway Lr	19.66	-5	d. Sealed thick win	10
				Road	Sleeping			0 to 90 degrees			Door			Very Absorptive				F - Diesel Railway Lr			c. Sealed thin wind	